ILLINOIS CENTRAL COLLEGE

WORKFORCE TRAINING FACILITIES IMPROVEMENTS

1 College Dr, East Peoria, IL 61635

ISSUED FOR BID 01/17/2023





ILLINOIS CENTRAL COLLEGE - PEORIA CAMPUS

- LOCATION OF PROPOSED STORAGE & BREAK AREA

Client

Illinois Central College Peoria Campus

Attn: Campus Representative 1 College Drive East Peoria, IL 61635 CONTACT PHONE #

Architect & Engineer

The HOH Group, Inc. Attn: Amer Sassila, RA, LEED AP, BD+C; Director of A/E

> Travis Miller, RA, Senior Project Architect

623 Cooper Court Schaumburg, IL 60173 630.346.2208 amers@hohgroup.com tmiller@hohgroup.com

General Contractor



ILLINOIS CENTRAL COLLEGE

Illinois

College

Central

623 COOPER COURT SCHAUMBURG, IL 60173 (312) 346-8181

STATEMENT OF COMPLIANCE ERVISION, THE ATTACHED PLANS AND SPECIFICATIONS. I STATI AT, TO THE BEST OF MY KNOWLEDGE AND BELIEF AND TO THE

001.024865 12/21/2022



ISSUED FOR BID ISSUE DESCRIPTION

WORKFORCE **TRAINING FACILITIES IMPROVEMENTS**

PROJECT NO. 5538

COVER SHEET

1 College Dr, East Peoria, IL 61635

TKM DESIGN BY: CHECKED BY: JBA / AS

SHEET NO.

G0.00

SHEET INDEX

SHEET NAME

GENERAL INFORMATION, SYMBOLS,

ARCHITECTURAL SPECIFICATIONS

ARCHITECTURAL SITE PLAN

FLOOR PLAN, ELEVATIONS,

REFLECTED CEILING PLAN

EXTERIOR WALL SECTIONS

SCHEDULE, WINDOW & DOOR

GENERAL

COVER SHEET

& ABBREVIATIONS

ARCHITECTURAL

PAVEMENT DETAILS

OVERALL SECTIONS

DETAILS

SHEET

NUMBER

G0.00

G0.01

G0.02

A1.00

A1.01

A2.00

A3.00

A5.00

A5.01

A6.00

GENERAL NOTES

1. WORK, MATERIALS AND METHODS SHALL BE IN CONFORMANCE WITH THE

2. UNLESS OTHERWISE INDICATED IN THE CONSTRUCTION DOCUMENTS AS

BEING NOT IN CONTRACT (N.I.C.) OR EXISTING, ITEMS, MATERIALS AND

INSTALLATION OF SAME ARE PART OF THE CONTRACT AS DEFINED BY

THE CONTRACT DOCUMENTS. THE CONTRACTORS SHALL PROVIDE AND

INSTALL ACCESSORIES. COMPONENTS AND ASSEMBLIES REQUIRED FOR

DIMENSIONS AND EXISTING CONDITIONS BEFORE COMMENCING WORK.

INSPECTED IN ACCORDANCE WITH THE APPLICABLE CODES WHERE

APPLICABLE. THIS INCLUDES FIRE DAMPERS OR FIRE DOORS PROVIDED

WHERE AIR DUCTS OR OPENINGS PENETRATE FIRE-RATED SURFACES.

PENETRATIONS OF RATED FIRE-RESISTIVE CONSTRUCTION SHALL BE

5. PENETRATIONS THROUGH SURFACES SHALL BE SEALED WITH SEALANT

6. DESIGN BUILDER SOLELY RESPONSIBLE FOR COORDINATION AMONG

8. PROVIDE GALVANIC PROTECTION BETWEEN DISSIMILAR MATERIALS,

9. KEEP PIPING AS CLOSE TO WALLS AS POSSIBLE UNLESS NOTED

10. NO CONTRACTORS SHALL CLOSE OR OBSTRUCT STREETS, DOCKS,

11. CONTRACTORS SHALL PROVIDE AND ARE SOLELY RESPONSIBLE AND

ALLEYS OR WALKS. NO MATERIALS ARE TO BE PLACED OR STORED IN

STREETS, ALLEYS, OR WALKS. DEBRIS TO BE REMOVED COMPLETELY

LIABLE FOR PUBLIC AND EMPLOYEE PROTECTIONS AS NECESSARY AND IS

REQUIRED BY THE CODES, INCLUDING EXTERIOR, INTERIOR PEDESTRIAN

AND TRAFFIC BARRIERS. EXISTING EXIT CORRIDORS, PATHS OF EXITS,

STAIRWAYS, OR EXIT SIGNAGE, MUST HAVE CLEAR MEANS OF EGRESS

12. CONTRACTORS WISHING TO WORK IN THE BUILDING OR ON THE BUILDING

CERTIFICATES OF INSURANCE TO THE OFFICE OF THE DESIGN BUILDER.

JURISDICTION. LICENSES AND BONDING ARE TO BE INCLUDED IN THE BID

CONTRACTORS ARE REQUIRED TO BE LICENSED WITH THE LOCAL

13. DIMENSIONS NOTED ON THE ARCHITECTURAL FLOOR PLAN REGARDING

DETAILS AND PARTITION THICKNESSES ARE NOMINAL DIMENSIONS.

DETAILS AND SECTIONS SHOULD BE REFERRED TO FOR THE EXACT

HISTORICAL OR ARCHAEOLOGICAL ARTIFACT SHALL BE IMMEDIATELY

NOTIFICATION PROCESS AND FURTHER DIRECTIONS ISSUED BY EDA

AFTER CONSULTATION WITH THE STATE HISTORIC PRESERVATION

OFFICER (SHPO) FOR RECOVER OF THE ITEMS. SEE THE NATIONAL

HISTORIC PRESERVATION ACTO OF 1966 (54 U.S.C. & 300101 ET SEQ

FORMERLY AT 16 U.S.C. & 470 ET SEQ.) AND EXECUTIVE ORDER NO. 11593

ARCHITECTURAL NOTES

1. WORK, MATERIALS AND METHODS SHALL BE IN CONFORMANCE WITH THE

2. ALL SITE AREAS AFFECTED BY DEMOLITION TO BE PATCHED, REPAIRED.

AND LEVELED TO MATCH EXISTING ADJACENT SURFACE TO REMAIN,

3. THE CONSTRUCTION DOCUMENTS INDICATE THE OVERALL AREAS OF

WORK. INCIDENTAL WORK ASSOCIATED BUT NOT SHOWN ON THE

CONSTRUCTION DOCUMENTS MAY BE REQUIRED OUTSIDE OF THE

CONTRACT AND IS TO BE COMPLETED IN ACCORDANCE WITH THE

CONTRACT REQUIREMENTS AT NO ADDITIONAL COST TO THE OWNER.

4. WHEN THE REMOVAL OF EXISTING SURFACE MATERIAL IS REQUIRED TO

5. REFER TO MEPF DRAWINGS FOR DEMOLITION / REMOVAL / RELOCATION AND INSTALLATION OF ALL BUILD-IN FIXTURES AND DEVICES ON SITE.

6. REFER TO SHEET G0.1 FOR TYPICAL FIXTURE MOUNTING HEIGHTS AND

FINISH GENERAL NOTES

1. ALL GYPSUM BOARD WALLS AND CEILINGS TO RECEIVE EPOXY, SHERMAN

1. PROVIDE 4" BLACK VINYL BASE BY JOHNSONITE OR APPROVED EQUAL AT

1. CONCRETE FLOORING TO BE FINISHED WITH DIAMOND GRIND WITH

2. EXPOSED STRUCTURAL STEEL COLUMNS TO BE CLEAR FACTORY FINISH

3. PAINT ALL BOLLARDS SAFETY YELLOW WITH EXTERIOR GRADE PAINT

1. EXTERIOR INSULATED METAL DOOR AND FRAME UPT-1 U.N.O.

WILLIAMS "INCREDIBLE WHITE" (SW 7028) OR APPROVED EQUAL.

2. EXTERIOR WALLS TO BE EITHER CORRUGATED METAL PANELS OR

SMOOTH METAL PANELS; SEE ARCHITECTURAL ELEVATIONS.

ALL GYPSUM WALL BOARDS.

CLEAR EPOXY FINISH.

MISCELLANEOUS

ADA COMPLIANT PLANS, ELEVATIONS AND DETAILS.

COMPLETE CONTRACT WORK AND A NEW FINISH IS NOT SCHEDULED. PATCH/REPAIR AND PRIME THE AFFECTED SURFACE TO RECEIVE NEW

PROJECT AREAS. THIS WORK IS PART OF THE CONSTRUCTION

HAVING JURISDICTION AT THE PROJECT LOCATION.

CODES, ORDINANCES AND REGULATIONS OF GOVERNMENTAL AGENCIES

14. ANY EXCAVATION BY THE CONTRACTOR THAT UNCOVERS ANY

REPORTED TO THE OWNER AND A REPRESENTATIVE OF EDA.

CONSTRUCTION SHALL BE TEMPORARILY HALTED PENDING THE

PROPERTY SHALL BE REQUIRED TO PRESENT THE PROPER

PER THE REQUIREMENTS IN THE SPECIFICATIONS.

7. IN THE EVEN OF DISCREPANCIES BETWEEN DRAWINGS AND/OR

MATERIAL PER SPECIFICATIONS FOR PLUMBING, FIRE SPRINKLER AND

SPECIFICATIONS, THE MORE COSTLY OR MORE RESTRICTIVE CONDITIONS

SHALL BE DEEMED THE CONTRACT REQUIREMENT UNLESS OTHERWISE

REPORT DISCREPENCIES AND/OR POTENTIAL PROBLEMS TO THE DESIGN

HAVING JURISDICTION AT THE PROJECT LOCATION.

3. EACH CONTRACTOR SHALL BE RESPONSIBLE FOR VERIFYING

BUILDER PRIOR TO PROCEEDING WITH AFFECTED WORK.

4. FIRE-RATED ASSEMBLIES SHALL BE INSTALLED, LABELED, AND

PROTECTED WITH APPROVED FIRE ASSEMBLIES.

STATED IN WRITING FROM THE DESIGN BUILDER.

DURING PHASES OF CONSTRUCTION.

ELECTRICAL SYSTEMS WHERE APPLICABLE

VARIOUS SUBCONTRACTORS.

OTHERWISE.

DIMENSION.

OF MAY 31, 1971.

VERIFY IN FIELD.

THE WORK DEPICTED OR SPECIFIED.

CODES, ORDINANCES AND REGULATIONS OF GOVERNMENTAL AGENCIES

ILLINOIS CENTRAL COLLEGE

THE HOH GROUP, INC.

623 COOPER COURT SCHAUMBURG, IL 60173 (312) 346-8181

STATEMENT OF COMPLIANCE

HAVE PREPARED OR CAUSED TO BE PREPARED LINDER MY DIRECT THAT. TO THE BEST OF MY KNOWLEDGE AND BELIEF AND TO THE COMPLIANCE WITH THE 2015 INTERNATIONAL BUILDING COD DEPARTMENT/CODE ENFORCEMENT AND THE ILLINOIS ACCESSIBILITY CODE, 71 IL ADM. CODE 400.

ARCHITECT/ENGINEER

001.024865 ILLINOIS REGISTRATION NO.: 12/21/2022





ISSUED FOR BID

ISSUE DESCRIPTION

01/17/2023

DATE

WORKFORCE TRAINING

FACILITIES

IMPROVEMENTS 1 College Dr, East Peoria, IL 61635

PROJECT NO. 5538

GENERAL INFORMATION, SYMBOLS, & **ABBREVIATIONS**

TKM DESIGN BY: TKM DRAWN BY: CHECKED BY: JBA / AS

SHEET NO.

G0.01

1. APPLICABLE CODES

BUILDING: 2018 INTERNATIONAL BUILDING CODE MECHANICAL: 2018 INTERNATIONAL MECHANICAL CODE ELECTRICAL 2017 NATIONAL ELECTRIC CODE PLUMBING: 2014 ILLINOIS PLUMBING CODE ACCESSIBILITY: 2018 ILLINOIS ACCESSIBILITY CODE **ENERGY:** 2018 INTERNATIONAL ENERGY CONSERVATION CODE FIRE: 2018 INTERNATIONAL FIRE CODE

2018 NFPA 101 LIFE SAFETY CODE

2. GENERAL BUILDING DESCRIPTION

OCCUPANCY CLASSIFICATION:

GROSS BUILDING AREA (NEW) 512 S.F. **SECTION 302** 3. BUILDING OCCUPANCY TYPE

4. CONSTRUCTION TYPE **SECTION 503, 602** CONSTRUCTION TYPE: TYPE VB FIRE RESISTANCE RATING REQUIREMENTS TABLE 601 STRUCTURAL FRAME: 0 HR BEARING WALLS (EXTERIOR) (ALSO SEE TABLE 602): 0 HR

BEARING WALLS (INTERIOR): 0 HR NON-BEARING WALLS (EXTERIOR): SEE TABLE 602 NON-BEARING WALLS (INTERIOR): 0 HR FLOOR CONSTRUCTION: 0 HR ROOF CONSTRUCTION: 0 HR

EXTERIOR WALL FIRE SEPARATION DISTANCE TABLE 602 LESS THAN 5' 2 HR LESS THAN OR EQUAL TO 5' TO LESS THAN 10' LESS THAN OR EQUAL TO 10' TO LESS THAN 30'

GREATER THAN OR EQUAL TO 30' 5. ALLOWABLE HEIGHT AND **SECTION 503 AREA LIMITATIONS** BASE ALLOWABLE AREA 9,000 S.F.

BASE ALLOWABLE HEIGHT (FEET): 40'-0" BASE ALLOWABLE HEIGHT (STORIES): 1 STORY 6. AUTOMATIC SPRINKLER SYSTEMS **SECTION 903**

PER SECTION 903.2.9 GROUP S-1, CONDITIONS 1 THRU 5 DO NOT APPLY TO OUR BUILDING APPLICATION AND THEREFORE EXEMPT THE USE OF AN AUTOMATIC FIRE SPRINKLER SYSTEM

7. OCCUPANT LOAD AND MEANS **SECTION 1004 OF EGRESS** MAXIMUM FLOOR AREA ALLOWANCES PER **TABLE 1004.5**

OCCUPANT STORAGE AREA 300 GROSS (2 PERSONS TOTAL) MEANS OF EGRESS **SECTION 1005.3**

2 OCCUPANTS x 0.2"/OCCUPANT = MIN. 0.4" EGRESS REQUIRED

HEATING, VENTILATION & AIR HVAC CONDITIONING ICC ILLINOIS CENTRAL COLLEGE INCH/INCHES INSUL. INSULATION INTERIOR **JOINT** LAV LAVATORY LINO. LINOLEUM LB/LBS POUNDS LP **LOW POINT**

ACCESS.

ACOUST

ADA

A.F.F.

ALT.

ALUM./AL

APPROX

ASTM

BLDG.

B/O

BRK. CAB. C.C.

CMU

COL.

CLR.

CONC

CONT.

CORR

DEMO

DIA.

DR.

DS

EA.

EIFS

ELEC.

ELEV.

EQ.

EQUIP

EWC

EXP

EXT

FD

FEC

FL./FLR.

FOUND.

FT.

FTG.

GALV.

GWB/

НМ

LVL.

MAT

MAX.

MAS.

MFR./

MANUF.

HT/HGT.

GYP. BD

EXIST.

DWGS.

CPT.

CONTR

STORAGE (S-1)

ACCESSIBLE

ACOUSTICAL

ALTERNATE

ALUMINUM

MATERIALS

BOARD

BREAK

CABINET

CEILING

CONCRETE

CORRIDOR

CARPET

CONTINUOUS

CONTRACTOR

CERAMIC TILE

DEMOLITION

DIMENSIONS

DOWN SPOUT

DRAWINGS

ELEVATION

ELECTRICAL

EQUIPMENT

EXPANSION

FACTORY FINISH

EXTERIOR

EXISTING

FINISHED

FOUNDATION

GALVANIZED

HEAVY DUTY

HIGH POINT

HEIGHT

LEVEL

MENS

MATERIAL

MAXIMUM

MASONRY

MANUFACTURER

FIREPROOFING

HOLLOW METAL

GYPSUM WALL BOARD

HIGH DENSITY SPRAYED

FOOT/FEET

FOOTING

GAUGE

FLOOR

DIAMETER

DOOR

EACH

EQUAL

ACCESS CARD READER

EXTERIOR INSULATED FINISH

ELEVATION/ELEVATOR

ELECTRIC WATER COOLER

FIRE EXTINGUISHER CABINET

EXPANSION JOINT

CLEAR

BUILDING

BOTTOM OF

CENTERLINE

CONTROL JOINT

CENTER TO CENTER

AUDIO VISUAL

APPROXIMATE

ARCHITECTURA

AMERICAN CONCRETE INSTITUTE

AMERICANS WITH DISABILITIES

ABOVE FINISHED FLOOR

MEDIUM DENSITY SPRAYED MDSFP **FIREPROOFING** MEDIUM DENSITY FIBERBOARD MIL. MILLIMETERS MIN. MINIMUM MISC. **MISCELLANEOUS** MHO MAGNETIC HOLD OPEN M.O. MASONRY OPENING NECESSARY N.I.C NOT IN CONTRACT NO. NUMBER NTS NOT TO SCALE O.C. ON CENTER

AMERICAN SOCIETY FOR TESTING OD. **OUTSIDE DIAMETER** OFCI OWNER FURNISHED CONTRACTOR INSTALLED OWNER FURNISHED OWNER INSTALLED OVERFLOW ROOF DRAIN P.B. PIPE BOLLARD PERS. PERSON **CONCRETE MASONRY UNIT** PI ATF PL./ PLASTIC LAMINATE P LAM PLY.

R.O.

RTU

SD

SGFT.

TYP.

WD

ABBREVIATIONS

PLYWOOD DOOR ACTUATOR PUSH PLATE PSF POUNDS PER SQUARE FEET PSI POUNDS PER SQUARE INCH PT/PTD PAINT/PAINTED P.T. PRESSURE TREATED RAD. RADIUS RCP REFLECTED CEILING PLAN REFL. REFLECTING/REFLECTED RESTRM RESTROOM

ROOM ROUGH OPENING **ROOF TOP UNIT** SOUND ATTENUATION FIBER **BATT INSULATION** SEALED CONCRETE SCHD./


SCHEDULE SCHED SCHEMATIC DESIGN SQUARE FEET STRUCTURAL GLAZED FACING SHEET SIMILAR STEEL JOINT INSTITUTE SHEET METAL

SHT. SIM. SJI. S.M. SPA. SPACES SPEC. **SPECIFICATIONS** STONE TILE SOUND CLASS TRANSMISSION STC STB. STONE TILE BASE STL. STEEL ANGLE STAINLESS STEEL STOR. STORAGE **STRUCT** STRUCTURAL SHEET VINYL SYN.


SYNTHETIC TOP OF T/FTG. TOP OF FOOTING **TEXTURED PAINT** TYPICAL

UNLESS NOTED OTHERWISE U.S.R.D. UNDERSIDE OF ROOF DECK UNITED STATES GEOLOGICAL USGS SURVEY VINYL BASE VCT. VINYL COMPOSITION TILE VERT. VERTICAL V.I.F. VERIFY IN FIELD VINYL WALL COVERING WC


WATER CLOSET WOOD WOMENS W/O WITHOUT WELDED WIRE FABRIC ENLARGED PLAN SYMBOL

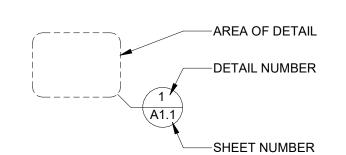


INTERIOR ELEVATION SYMBOL

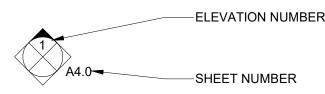


EXTERIOR ELEVATION SYMBOL

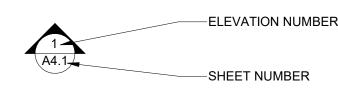


EXTERIOR MARK SYMBOL

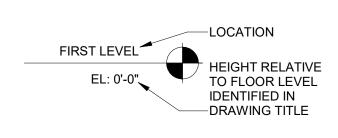

BUILDING/WALL SECTION SYMBOL

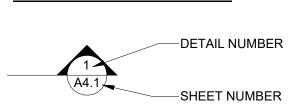


DOOR TAG SYMBOL

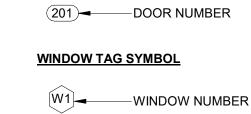

KEYNOTE NUMBER

KEYNOTE TAG SYMBOL

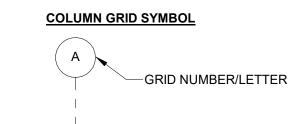

PARTITION TAG SYMBOL




ROOM TAG SYMBOL

ROOM


── ROOM NAME

NORTH ARROW

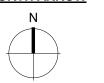

201 ROOM NUMBER

REVISION SYMBOL

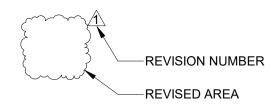


CLADDING LOCATION ROOFS - ATTIC & OTHER REQUIRED R-VALUE PROVIDED R-VALUE R-8 MIN. + R-30 = R-38 MIN. (1.5" MIN. FOIL-FACED POLYISO + 9" FIBERGLASS **BATT INSULATION)** R-13 + R-3.8 CI R-21 FACED BATT INSULATION WALLS, ABOVE GRADE (WOOD FRAMED & OTHER) **OR** R-20 (5.5" FIBERGLASS BATT INSUL. @ WOOD STUDS) WALLS, BELOW GRADE R-10 MIN. RIGID INSULATION @ WALL INTERIOR SLAB-ON-GRADE FLOORS R-10 FOR 24" BELOW R-10 MIN. RIGID INSULATION @ 24" MIN. BELOW (UNHEATED) OPAQUE SWINGING DOORS U-0.37 U-0.35 MIN. OR BETTER

OPERABLE FENESTRATION U-0.38 & 0.61 SHGC U-0.35 MIN. AND 0.61 OR BETTER

2018 IECC - TABLE C402.1.3 & C402.4

TYPICAL FIXTURE MOUNTING HEIGHTS

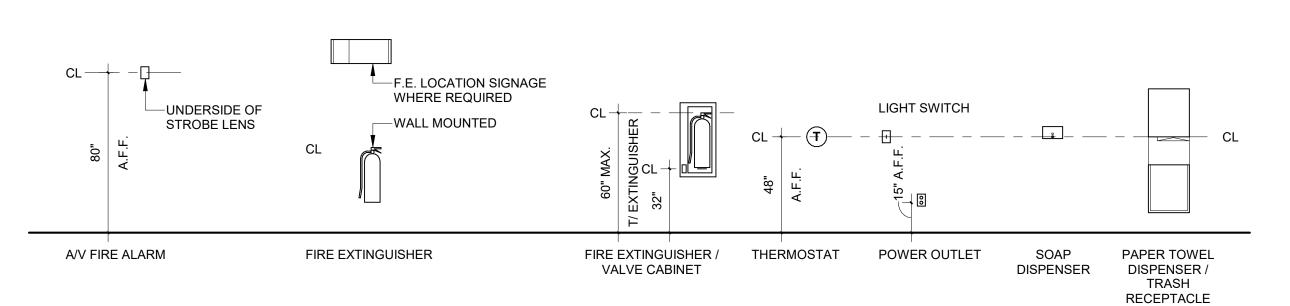

THE CURRENT EDITION OF AIA DOCUMENT A-201 "GENERAL CONDITIONS OF THE CONTRACT FOR CONSTRUCTION" SHALL BE APPLICABLE AND IS HEREBY INCORPORATED IN THE CONSTRUCTION DOCUMENTS FOR THIS WORK. CONTRACTOR SHALL PROVIDE A COMPLETE FINISHED AND OPERATIONAL PROJECT UNDER THE SCOPE OF THE CONSTRUCTION CONTRACT.

WHERE SPECIFIC DIMENSIONS, DETAILS, OR DESIGN INTENT CANNOT BE DETERMINED FROM THE DRAWINGS, CONSULT THE ARCHITECT PRIOR TO PROCEEDING WITH THE WORK ALL WORK SHALL BE IN ACCORDANCE WITH ALL BUILDING CODES AND REGULATIONS ADOPTED BY THE CITY OF EAST PEORIA, IL INCLUDING

THE ILLINOIS ACCESSIBILITY CODE. SHOULD PROVISIONS OF THESE CODES AND STANDARDS BE CONTRARY TO THE CONSTRUCTION DOCUMENTS, BIDDERS WILL SO ADVISE THE ARCHITECT OR OWNER WITHOUT DELAY. CONTRACTOR SHALL VISIT AND VERIFY EXISTING CONDITIONS AND DIMENSIONS. CONTRACTOR SHALL IMMEDIATELY NOTIFY THE ARCHITECT

VIOLATIONS CONTRACTOR SHALL PROVIDE THE OWNER WITH WRITTEN NOTICE OF THE EXISTENCE OF ANY HAZARDS MATERIALS LOCATED ON THE PROJECT WITHIN FIVE (5) BUSINESS DAYS OF CONTRACTOR'S BECOMING AWARE OF THE EXISTENCE OF SUCH HAZARDOUS MATERIALS, AND IN ANY EVENT PRIOR TO DISTURBING SUCH HAZARDOUS MATERIALS. CONTRACTOR SHALL NOT BE OBLIGATED TO REMEDIATE OR REMOVE

IF ANY DISCREPANCIES ARISE PERTAINING TO THE DRAWINGS. CONTRACTOR SHALL NOTIFY THE ARCHITECT AND OWNER OF ANY CODE

ANY EXISTING HAZARDOUS MATERIALS. CONTRACTOR SHALL OBTAIN AND PAY FOR BUILDING PERMIT. CONTRACTOR SHALL BE RESPONSIBLE FOR PAYMENT OF ALL APPLICABLE FEES. CONTRACTOR SHALL INCLUDE AN ALLOWANCE IN THEIR BID FOR THE COST OF ALL PERMITS AND FEES. CONTRACTORS SHALL BE REGISTERED WITH THE CITY OF EAST PEORIA AS REQUIRED.

ALL CONSTRUCTION WORK SHALL BE IN ACCORDANCE WITH THE OWNER'S RULES AND REGULATIONS. INSURANCE COVERAGE SHALL NAME THE OWNER, NORTH SHORE CENTER FOR THE PERFORMING ARTS, AND THE ARCHITECT, THE HOH

GROUP, INC. AND ITS CONSULTANTS AS ADDITIONAL NAMED INSURED. ALL CONTRACTORS ARE RESPONSIBLE FOR PROPERLY STORING MATERIALS ON SITE AND PROTECTING MATERIALS AGAINST EXPOSURE TO WATER AND DAMPNESS. MATERIALS EXPOSED ARE TO BE DRIED OUT THOROUGHLY AND RETURNED TO THEIR ORIGINAL CONDITION PRIOR TO

CONTRACTOR TO COMPLY WITH BUILDING MANAGEMENT REGULATIONS AND COORDINATE USE OF COMMON AREAS PRIOR TO COMMENCEMENT OF WORK.

THE ARCHITECT SHALL NOT HAVE CONTROL OR CHARGE OF AND SHALL NOT BE RESPONSIBLE FOR CONSTRUCTION MEANS, METHODS, TECHNIQUES, SEQUENCES OR PROCEDURES, FOR SAFETY PRECAUTIONS & PROGRAMS IN CONNECTION WITH THE WORK, FOR THE ACTS OR OMISSIONS OF THE CONTRACTORS, SUBCONTRACTORS OR ANY OF THEM TO CARRY OUT THE WORK IN ACCORDANCE WITH THE CONTRACT DOCUMENTS.

CONTRACTOR TO COORDINATE ALL SUBMITTALS THAT ARE REQUIRED BY THE ARCHITECT IN A TIMELY MANNER. THE ARCHITECT WILL RESPOND TO THE CONTRACTOR WITHIN TEN BUSINESS DAYS AS APPROVED OR REQUEST FOR RESUBMITTAL. CONTRACTOR WILL RESUBMIT IN A TIMELY MANNER IF ORIGINAL IS REJECTED

CONTRACTOR SHALL SUBMIT SAMPLES AND SPECIFICATION SHEETS ON ALL SUBMITTALS TO THE ARCHITECT AND OWNER FOR APPROVAL PRIOR TO COMMENCEMENT OF WORK. CONTRACTOR SHALL PROVIDE ONE (1) RECORD SET OF DRAWINGS TO ARCHITECT WITHIN 30 CALENDAR DAYS OF COMPLETION OF THE

CONTRACTOR TO PROVIDE APPLICABLE WARRANTIES, MANUALS, AND GUARANTEES REGARDING SYSTEMS, EQUIPMENT, FIXTURES, AND

FINAL DRAWINGS SUBMITTAL: CONTRACTOR SHALL PROVIDE ELECTRONIC FILES (BOTH CAD OR REVIT & PDF FORMAT) ON A FLASH DRIVE, PLUS 1 PAPER COPY OF ALL COMPLETION DOCUMENTS TO THE OWNER. ALL WORK PERFORMED AND MATERIALS UTILIZED SHALL BE GUARANTEED FOR A PERIOD OF ONE YEAR AFTER THE DATE OF SUBSTANTIAL

COMPLETION OR LONGER IF SO SPECIFIED ELSEWHERE IN THE CONTRACT DOCUMENTS AGAINST DEFECTS IN WORKMANSHIP AND/OR MATERIALS.

OWNER'S POLICIES DO NOT ALLOW SMOKING WITHIN OR OUTSIDE THE BUILDING. WORK CREATING NOISE SHALL BE AS LIMITED BY APPLICABLE VILLAGE ORDINANCES.

CONTRACTOR SHALL GIVE OWNER TEN BUSINESS DAYS NOTICE PRIOR TO CLOSING AN EMERGENCY EXIT OR STOPPING WATER, HEATING/COOLING, OR ELECTRICAL SERVICE TO THE BUILDING FOR ANY PERIOD OF TIME.

INVITATION TO BID: A PRE-BID WALKTHROUGH OF THE PROJECT WILL BE SCHEDULED AT THE PROJECT'S LOCATION. INTERESTED BIDDERS WILL BE

NOTIFIED OF DATE AND TIME IN PROCUREMENT PACKAGE. ANY CONTRACTOR WISHING TO ATTEND MUST PRE-REGISTER WITH AMER SASSILA (AMERS@HOHGROUP.COM) AND TRAVIS MILLER (TMILLER@HOHGROUP.COM). EACH GENERAL CONTRACTOR IN ATTENDANCE 2 PERSONS IN ATTENDANCE ASSOCIATED WITH THE GENERAL CONTRACTOR

1 REPRESENTATIVE FROM THE GENERAL CONTRACTOR'S PREFERRED PAVEMENT INSTALLER

1 REPRESENTATIVE FROM THE GENERAL CONTRACTOR'S PREFERRED LIGHTING INSTALLER CONTRACTORS WISHING TO BID THIS PROJECT IN ITS ENTIRETY MUST SUBMIT THEIR BID PACKAGES NO LATER THAN 10:00 A.M. CENTRAL TIME ON 2/6/2023 TO ILLINOIS CENTRAL COLLEGE AS DIRECTED BY THE EDA. TO BE CONSIDERED, EACH BID PACKAGE MUST

INCLUDE: THE GENERAL CONTRACTOR'S ALL INCLUSIVE BID, ITEMIZED AND BROKEN DOWN BY TRADE. THE CITY OF EAST PEORIA DOES NOT REQUIRE UNION LABOR TO BE PROVIDED FOR THIS PROJECT AND ALL BIDS SHOULD ASSUME PREVAILING WAGES.

PROOF OF 5% BID BONDS BY THE GENERAL CONTRACTORS PROOF OF MANUFACTURER'S CERTIFICATION OF INSTALLERS OR PROOF MANUFACTURER WILL HONOR THEIR WARRANTY FOLLOWING INSTALLATION OF MATERIALS INDICATED IN THE CONTRACT DOCUMENTS.

PROPOSED CONSTRUCTION SCHEDULE WITH THE ASSUMED CONSTRUCTION DETAILING THE ESTIMATED TIME OF COMPLETION OF EACH TRADE AND THE PORTIONS OF THE PROJECT AS A WHOLE. ASSUMED CONSTRUCTION START DATE OF 3/01/2023

CONSTRUCTION SHALL REACH SUBSTANTIAL COMPLETION NO LATER THAN 130 BUSINESS CALENDAR DAYS AFTER 4/1/2023. REQUEST FOR EXTENSION SHALL BE REQUESTED BY CONTRACTOR NO LATER THAN 30 BUSINESS DAYS REMAINING FOR PROJECT. IF NO EXTENSION IS REQUESTED BY G.C. AND PROJECT DURATION EXCEEDS 130 DAYS WITHOUT EXTENSION GRANTED, G.C. WILL BE RESPONSIBLE TO PAY LIQUIDATED DAMAGES OF 1% OF THE CONSTRUCTION COST FOR EACH DELAYED WITHOUT APPROVAL FROM THE ILLINOIS CENTRAL COLLEGE.

STANDARD WORKING HOURS ARE MONDAY-FRIDAY FROM 7:00 AM TO 3:00 PM CENTRAL TIME ASSUMED CONSTRUCTION WORK TO NOT TAKE PLACE OUTSIDE OF THE HOURS LISTED ABOVE WITHOUT EXCEPTIONS AS DIRECTED BY JEFF LAGROW AND/OR TOM BRAUN.

ASSUMED A MINIMUM OF (1) CONSTRUCTION PROGRESS MEETING EACH WEEK TO BE HELD BY THE G.C. FOR THE OWNER, ARCHITECT AND/OR ENGINEERS, SUB-CONTRACTORS, OR OTHER OFFICIALS TO BE IN ATTENDANCE EITHER IN PERSON, VIA PHONE CALL, OR VIA VIDEO CONFERENCING ALL BIDS FOR THIS PROJECT SHALL ASSUME PREVAILING WAGES

PROOF OF INCLUSIVE INSURANCE POLICY FOR A MINIMUM OF \$1,000,000 (USD) OR PRE-AUTHORIZATION FROM POLICY SUPPLIER GRANTING COVERAGE UPON AWARDING OF CONTRACT AWARDING OF CONTRACT:

FOLLOWING RECEIPT AND CLOSURE OF BIDS RECEIVED ON 2/6/2023, THE ARCHITECT AND THE ILLINOIS CENTRAL COLLEGE WILL BEGIN VETTING EACH CONTRACTOR'S BIDDING DOCUMENTS. THE CONTRACT WILL BE AWARDED TO THE LOWEST. RESPONSIVE. AND RESPONSIBLE BIDDER THE TARGET DATE OF BOARD APPROVAL OF THE CONTRACT AWARD IS SCHEDULED FOR 2/19/2023. ALL GENERAL CONTRACTORS WHO

HAVE SUBMITTED A BID PRIOR TO THE OFFICIAL CLOSURE OF BIDS RECEIVED ON 2/6/2023 SHALL RECEIVE AN OFFICIAL ACCEPTANCE OR DENIAL OF THEIR BID PACKAGE, EITHER VIA PUBLIC NOTICING OF AWARD OF BID OR VIA OTHER NON-PUBLIC MEANS SUCH AS A PHONE CALL OR EMAIL. COMMENCING OF WORK

THE AWARDED GENERAL CONTRACTOR IS ASSUMED TO START WORK ON 3/01/2023 AND NO LATER THAN 4/1/2023

THE GENERAL CONTRACTOR AND THEIR SUB-CONTRACTORS MUST REGISTER WITH THE CITY OF EAST PEORIA AS REQUIRED. THE GENERAL CONTRACTOR IS RESPONSIBLE FOR THE COSTS AND SUBMITTAL OF THE PERMIT SET DRAWINGS AND ANY COMPONENT SUBMITTALS. ANY RESPONSES AND/OR APPROVAL FROM THE CITY OF EAST PEORIA SHOULD BE FORWARDED TO THE ARCHITECT AND OWNER FOR RESPONSES OR VERIFICATION AS REQUIRED.

A CONSTRUCTION KICK-OFF MEETING SHALL TAKE PLACE ON SITE PRIOR TO THE COMMENCEMENT OF ANY WORK BY THE GENERAL CONTRACTOR OR THEIR SUB-CONTRACTORS.

DURING CONSTRUCTION. THE GENERAL CONTRACTOR IS RESPONSIBLE FOR THE SECURITY OF ALL ITEMS WITHIN THE BOUNDARIES OF AREA OF WORK AND RESPONSIBLE TO CLEAN THE LOT OF ALL DEBRIS, SPILLED CHEMICALS, EQUIPMENT, AND/OR PRODUCTS AS RELATED TO STORAGE, DISPOSAL, AND MEANS AND METHODS OF CONSTRUCTION. SUBMITTALS AND SHOP DRAWINGS:

ARCHITECT AND/OR OWNER APPROVED PRODUCT DATA AND PRODUCT SAMPLE SUBMITTALS FOR ALL ITEMS ARE REQUIRED PRIOR TO THE START OF CONSTRUCTION ON 3/01/2023.

ARCHITECT APPROVED SHOP DRAWING SUBMITTALS ARE REQUIRED PRIOR TO THE START OF WORK AS CONTAINED IN EACH SHOP DRAWING SUBMITTAL

DO NOT SCALE DRAWINGS - WRITTEN DIMENSIONS GOVERN. LARGE SCALE DETAILS GOVERN OVER SMALL SCALE.

VERIFY ALL DIMENSIONS AND CONDITIONS PRIOR TO INSTALLATION OF WORK.

GIVEN DIMENSIONS ARE FROM FINISH TO FINISH UNLESS NOTED OTHERWISE INSTALL MATERIALS AND SYSTEMS IN PROPER RELATION WITH ADJACENT CONSTRUCTION AND WITH UNIFORM APPEARANCE. MATERIALS AND SYSTEMS SHOWN SHALL BE DELIVERED, STORED, HANDLED, AND INSTALLED IN ACCORDANCE WITH MANUFACTURER'S WRITTEN INSTRUCTIONS AND REVIEWED SUBMITTALS.

REMOVE AND PROPERLY DISPOSE OF CONSTRUCTION DEBRIS ACCORDING TO APPLICABLE LAWS AND REGULATIONS AS REQUIRED TO ACCOMMODATE CONSTRUCTION. THE CONTRACTOR SHALL REMOVE FROM TIME TO TIME AS DIRECTED, ALL RUBBISH AND DEBRIS AND UPON COMPLETION REMOVE ALL EQUIPMENT AND PERFORM FINAL CLEANING AS MAY BE NECESSARY TO LEAVE THE JOB READY FOR OCCUPANCY. CONTRACTOR SHALL DAILY REMOVE FROM THE SITE ALL COMBUSTIBLE BUILDING REFUSE INCLUDING SCRAP LUMBER, PAPER, ETC. ALL PACKING CASES, CRATES, AND CARTONS IN WHICH CONSTRUCTION MATERIALS HAVE BEEN DELIVERED SHALL BE REMOVED IMMEDIATELY. THE BURNING OF REFUSE WILL NOT BE PERMITTED. CONTRACTOR SHALL SEPARATE OUT ITEMS SUCH AS PAPER, PLASTIC, CARDBOARD, AND

ANY DRILLING, WELDING OR OTHER ATTACHMENT TO THE STRUCTURAL SYSTEM SHALL BE SUBJECT TO APPROVAL BY THE OWNER PRIOR TO COMMENCEMENT OF SUCH WORK.

CONTRACTOR SHALL PROVIDE FOR TEMPORARY FIRE PROTECTION DURING CONSTRUCTION. CONTRACTOR SHALL PROVIDE TEMPORARY BARRICADES TO PROTECT THE PUBLIC FROM CONSTRUCTION HAZARDS. BARRICADES SHALL BE EDGE GUARD DUST FREE BARRIER SYSTEM (217-552-5418) OR EQUAL.

CONTRACTOR SHALL FOLLOW REQUIREMENTS OF THE 2012 INTERNATIONAL BUILDING CODE, CHAPTER 33 - SAFEGUARDS DURING

ALL PENETRATIONS CREATED DURING CONSTRUCTION SHALL BE FIRE SEALED BY THE END OF EACH DAY CONTRACTOR TO PROVIDE PRODUCTS OF THE SAME KIND FROM A SINGLE SOURCE – INCLUDING MATERIAL, EQUIPMENT, SYSTEMS, ETC. **UPON COMPLETION, CONTRACTOR SHALL:**

ARRANGE FOR FINAL CLEANING OF ALL BUILDING AND SITE AREAS AS AFFECTED BY CONSTRUCTION

ARRANGE FOR FINAL INSPECTIONS TO OBTAIN CERTIFICATE/S OF OCCUPANCY BY APPROVAL AUTHORITIES FINAL CLEANING: CLEAN EACH SURFACE OR ITEM AS FOLLOWS BEFORE REQUESTING INSPECTION FOR CERTIFICATION OF SUBSTANTIAL COMPLETION.

REMOVE LABELS THAT ARE NOT PERMANENT. CLEAN TRANSPARENT MATERIALS, INCLUDING MIRRORS. REMOVE EXCESS GLAZING COMPOUNDS. REPLACE CHIPPED OR BROKEN

CLEAN EXPOSED FINISHES TO A DUST-FREE CONDITION, FREE OF STAINS, FILMS, AND FOREIGN SUBSTANCES. LEAVE CONCRETE FLOORS BROOM CLEAN. VACUUM CARPETED SURFACES AND SWEEP RESILIENT FLOORING.

WIPE SURFACES OF MECHANICAL AND ELECTRICAL EQUIPMENT. REMOVE EXCESS LUBRICATION. CLEAN PLUMBING FIXTURES. CLEAN

LIGHT FIXTURES AND LAMPS. FLOORING CONTRACTOR SHALL BE RESPONSIBLE FOR WAXING VINYL FLOORING WHERE REQUIRED. ALLOWANCES & UNIT COSTS

ALL ALLOWANCES AND UNIT COSTS SHALL HAVE A SHORT SUMMARY OF ASSOCIATED SCOPE, SERVICES, AND QUALIFICATIONS WITH THE ASSUMED COSTS FOR THE CONSTRUCTION MANAGER'S REVIEW. WRITTEN NOTICE FOR OFFICIAL COSTS APPROVAL AS DETERMINED WITH FINAL SITE CONDITIONS SHALL BE PROVIDED TO THE OWNER AND OWNER'S REPRESENTATIVE A MINIMUM OF TEN BUSINESS DAYS AHEAD OF BILLING FOR ASSOCIATED PORTIONS OF WORK AND SHALL PROVIDE A TABULATED QUANTITY OR SIZE, THE COST PER UNIT ACQUIRED INCLUDING INSTALLATION, AND THE TOTAL COSTS IN A CLEAR AND CONCISE MANNER FOR APPROVALS. IN THE EVENT WORK WOULD REQUIRE MULTIPLE BILLINGS AND/OR APPROVALS, A SEPARATE WRITTEN NOTICE SHALL BE PROVIDED FOR EACH OCCURRENCE THAT CLEARLY CALLS OUT PRIOR AMOUNTS PAID, ANY OUTSTANDING BALANCES DUE, AND THE CURRENT WORK BEING BILLED WITH A FINAL CALCULATED AMOUNT BEING REQUESTED AT TIME OF BILLING.

ALL SUBSTITUTION REQUESTS SHALL HAVE A SHORT SUMMARY OF ASSOCIATED SCOPE. SERVICES. AND QUALIFICATIONS WITH THE ASSUMED COSTS FOR THE CONSTRUCTION MANAGER'S AND OWNER'S REVIEW. THE INCLUSION OF ANY SUBSTITUTIONS ARE SEPARATE COSTS OUTSIDE OF THE INITIAL BIDDING COSTS TO THE OWNER FOR THE PROJECT AS ENCLOSED IN THIS DRAWING DOCUMENT SET AND ARE NOT CONSIDERED AS PART OF THE CONTRACT DOCUMENTS UNTIL APPROVAL BY OWNER. AT THAT TIME, ONLY THE PORTIONS OF WORK SPECIFIED IN THE WRITTEN APPROVAL OR NOTICE TO PROCEED SHALL BE COMPLETED BY THE CONTRACTOR AT THE COST TO THE OWNER AS LISTED WITHIN THE ORIGINAL BIDDING ESTIMATES. UNLESS A PRIOR AGREEMENT HAS BEEN AGREED TO AND SPECIFIED WITHIN THE WRITTEN AUTHORIZATION AND/OR NOTICE TO PROCEED. CONTRACTOR IS RESPONSIBLE FOR ALL COSTS FOR MATERIALS, INSTALLATION, PERMITS, SUBMITTALS, AND TESTING AS REQUIRED BY THE CITY OF EAST PEORIA, OWNER, ARCHITECT/ENGINEER, AND/OR MANUFACTURER.

DIVISION 02: EXISTING CONDITIONS

 SELECTIVE DEMOLITION
 THE CONTRACTOR SHALL COMPLY WITH ALL REQUIREMENTS AND CODES SET FORTH BY THE CITY OF EAST PEORIA AND THE OWNER. PARTIAL REMOVAL

ITEMS IDENTIFIED TO BE SALVAGED TO THE OWNER ARE TO BE CAREFULLY REMOVED AND TURNED OVER TO THE OWNER FOR STORAGE AND FUTURE REUSE

ITEMS IDENTIFIED TO BE SALVAGED FOR REUSE ARE TO BE CAREFULLY REMOVED AND STORED AND PROTECTED UNTIL THEY CAN BE INCORPORATED INTO THE PROJECT. ITEMS OF SALVAGEABLE VALUE TO THE CONTRACTOR MAY BE REMOVED FROM THE STRUCTURE AS WORK PROGRESSES. SALVAGED ITEMS MUST BE TRANSPORTED FROM THE SITE AS THEY ARE REMOVED.

STORAGE OR SALE OF REMOVED ITEMS ON SITE WILL NOT BE PERMITTED CONTRACTOR SHALL ENSURE SAFE PASSAGE OF PERSONS AROUND AREA OF DEMOLITION.

CONTRACTOR SHALL PROMPTLY REPAIR DAMAGES CAUSED TO ADJACENT FACILITIES AT NO COST TO THE OWNER.

REMOVE ALL DEBRIS FROM SITE AND DISPOSE OF OFF-SITE ON A DAILY BASIS. COORDINATE WASTE REMOVAL WITH BUILDING MANAGEMENT SCHEDULE & REQUIREMENTS, COMPLYING WITH ALL REGULATORY REQUIREMENTS FOR DISPOSAL MAINTAIN AND PROTECT EXISTING UTILITIES TO REMAIN IN SERVICE BEFORE PROCEEDING WITH DEMOLITION. SUBMIT REQUEST FOR UTILITY AND OTHER SYSTEMS SHUTDOWNS TO OWNER IN ADVANCE.

NEATLY CUT OPENINGS AND HOLES PLUMB, SQUARE, AND TRUE TO DIMENSIONS REQUIRED. USE CUTTING METHODS LEAST LIKELY TO DAMAGE CONSTRUCTION TO REMAIN OR ADJOINING CONSTRUCTION.

LOUD OR DISRUPTIVE DEMOLITION ACTIVITIES ARE TO BE SCHEDULED WITH THE OWNER IN ADVANCE AND MAY REQUIRE OFF HOURS WORK. CONTRACTOR SHALL ENTIRELY REMOVE ALL ABANDONED CABLES INCLUDING LOW VOLTAGE DURING CONSTRUCTION. CONTRACTOR SHALL COORDINATE WITH OWNER AND/OR APPROPRIATE GOVERNMENT AGENCIES PRIOR TO THE REMOVAL, STORAGE, AND RELOCATION OF EXISTING SITE EQUIPMENT AND SIGNAGE INCLUDED BUT NOT LIMITED TO POSTAL SERVICE BOXES, INFORMATIONAL AND WAYFINDING SIGNAGE, TRASH CANS, PLANTER BOXES, ADA PARKING SIGNAGE, OPERATIONAL SIGNAGE AND POSTERS, AND MOVEABLE BOLLARDS/POSTS ONLY AS THEY INTERFERE WITH THE SCOPE OF WORK AS DEFINED WITHIN THIS DRAWING SET. CONTRACTOR SHALL PROVIDE PROPER POSTINGS AND NOTIFICATION AS REQUIRED BY OWNER, VILLAGE, OR OTHER GOVERNMENT AGENCIES AS RELATED TO

THE REMOVAL OF AND RELOCATION OF ANY AND ALL ITEMS AS LISTED ABOVE. CONTRACTOR IS RESPONSIBLE FOR ALL REQUIRED TEMPORARY SIGNAGE POSTINGS AS RELATED TO WAYFINDING AND PUBLIC SAFETY DURING THE DEMOLITION AND CONSTRUCTION PORTIONS OF THE PROJECT.

DIVISION 07: THERMAL AND MOISTURE PROTECTION

CLEAN JOINT SURFACES IMMEDIATELY BEFORE INSTALLATION OF SEALANT. REMOVE DIRT, DUST, OIL, COATING, MOISTURE, OR OTHER FOREIGN MATTER WHICH WOULD INTERFERE WITH BOND OF SEALANT. ONE COMPONENT URETHANE SEALANT: POLYURETHANE BASED, ONE-PART ELECTROMETRIC SEALANT; COMPLY WITH ASTM C-920, TYPE S

GRADE NS, CLASS 25. COMPLY WITH SEALANT MANUFACTURERS PRINTED INSTRUCTIONS, EXCEPT WHERE MORE STRINGENT REQUIREMENTS ARE SHOWN OR

COLOR TO MATCH ADJACENT MATERIALS. CONTRACTOR TO SUBMIT SAMPLES FOR COLOR VERIFICATION TO ARCHITECT AND IDENTIFY ALL LOCATIONS REQUIRING COLOR SELECTIONS.

ALUMINUM SIDING AND SOFFITS

ACCEPTABLE MANUFACTURER: ROLLFAB METAL PRODUCTS OR APPROVED EQUAL. PRODUCT: ALUMABOARD OR APPROVED EQUAL.

PANEL SIZE: 8" - V GROOVE SIDING & SOFFIT PANEL LOCATION: ALUMINUM SIDING PANEL COLOR: MAPLE AND BLACK

TEXTURE: WOOD GRAIN AND SMOOTH

PANEL SYSTEM REQUIREMENTS INCLUDE THE FOLLOWING COMPONENTS: ALUMINUM-FACED COMPOSITE PANELS WITH MOUNTING SYSTEM. PANEL MOUNTING SYSTEM INCLUDING ANCHORAGES, FURRING,

FASTENERS, GASKETS AND SEALANTS, RELATED FLASHING ADAPTERS AND MASKING FOR A COMPLETE INSTALLATION. COMPONENTS DESIGNED TO WITHSTAND DEAD AND LIVE LOADS CAUSED BY POSITIVE AND NEGATIVE WIND PRESSURE ACTING NORMAL TO PLANE OF WALL AS CALCULATED IN ACCORDANCE WITH APPLICABLE CODES.

ACCOMMODATE MOVEMENT WITHIN SYSTEM WITHOUT DAMAGE TO COMPONENTS OR MOVEMENT WITHIN SYSTEM; MOVEMENT BETWEEN SYSTEM AND PERIMETER COMPONENTS WHEN SUBJECT TO SEASONAL TEMPERATURE CYCLING; DYNAMIC LOADING AND RELEASE OF LOADS; DEFLECTION OF STRUCTURAL SUPPORT FRAMING. PROVIDE POSITIVE DRAINAGE TO EXTERIOR FOR MOISTURE ENTERING OR CONDENSATION OCCURRING WITHIN PANEL SYSTEM.

PARAPET COPING, COLUMN COVERS, SOFFITS, SILLS, BORDER AND FILLER ITEMS MAY BE INDICATED AS INTEGRAL COMPONENTS OF THE PANELS SYSTEM OR AS DESIGNED.

ALL FLASHING METAL REQUIRED SHALL BE PROVIDED BY THE PANEL MANUFACTURER. SYSTEM TO BE FABRICATED AND INSTALLED PER LOCAL CODE REQUIREMENTS.

THE FABRICATION AND INSTALLATION OF COMPOSITE PANELS SHALL BE FROM A SINGLE SOURCE. IF NOT SINGLE SOURCE, BOTH PANEL FABRICATOR AND THE INSTALLER MUST SHOW PROOF OF PAST SUCCESSFUL COLLABORATION.

COORDINATE FABRICATION SCHEDULE WITH CONSTRUCTION PROGRESS AS DIRECTED BY THE CONTRACTOR TO AVOID DELAY OF WORK. MAXIMUM DEVIATION FROM VERTICAL AND HORIZONTAL ALIGNMENT OF ERECTED PANELS: 6 MM (1/4") IN 6 M (20') NON-ACCUMULATIVE. PANEL FABRICATOR AND INSTALLER SHALL ASSUME UNDIVIDED RESPONSIBILITY FOR ALL COMPONENTS OF THE EXTERIOR PANEL SYSTEM, INCLUDING BUT NOT LIMITED TO, ATTACHMENT TO SUB-CONSTRUCTION, PANEL-TO-PANEL JOINERY, PANEL-TO-DISSIMILAR-MATERIAL JOINERY AND JOINT SEAL ASSOCIATED WITH THE PANEL SYSTEM.

CONTRACTOR TO PROVIDE CERTIFICATION OF INSTALLERS AS PROVIDED BY THE MANUFACTURER; INSTALLER'S TO HAVE A MINIMUM OF 3 YEARS EXPERIENCE WITH ACM PRODUCTS AND MUST GUARANTEE MANUFACTURER'S WARRANTY FOLLOWING INSTALLATION OF PANELS.

FORMAL SUBMITTALS TO THE ARCHITECT/OWNER FOR APPROVAL SHALL CONTAIN THE FOLLOWING: SHOP DRAWINGS DETAILING THE FOLLOWING: PROJECT LAYOUT AND ELEVATIONS **FASTENING AND ANCHORING METHODS**

> DETAIL AND LOCATION/S OF JOINTS SEALANTS AND GASKETS INCLUDING THERMAL MOVEMENT JOINTS FLASHINGS

ADDITIONAL ACCESSORIES COORDINATION OF PROPOSED OPENINGS OR MOUNTED ASSEMBLIES FOR USE BY OTHERS POSTER DISPLAY CASES HANDRAIL MOUNTING TO PANEL FACE

MATERIAL SAMPLES OF THE FOLLOWING: FOR EACH FINISH PRODUCT SPECIFIED, TWO SAMPLES, MINIMUM SIZE 2" (51MM) X 3-1/2" (89MM), REPRESENTING ACTUAL PRODUCT, COLOR, AND GLOSS.

FABRICATION TICKETS: SUBMIT FABRICATION DRAWINGS SHOWING LOCATION AND TYPE OF ALUMINUM-EXTRUDED STIFFENERS AT TYPICAL PANELS AND AT CORNER PANELS, IF REQUIRED. THE FOLLOWING MINIMUM WARRANTY SHALL BE PROVIDED: THE FABRICATOR AND INSTALLER WILL WARRANT THE WALL SYSTEM FOR A PERIOD OF 1 YEAR THAT THE FABRICATION AND

INSTALLATION WORKMANSHIP WILL BE FREE FROM DEFECTS. POWDER-COATING MANUFACTURER MUST HAVE A MINIMUM OF FIVE YEARS OF DOCUMENTED EXPERIENCE PRODUCING ALUMINUM FINISHES OF THE TYPES SPECIFIED IN AAMA 2604 AND 2605.

INSTALLER MUST HAVE A MINIMUM OF THREE YEARS OF DOCUMENTED EXPERIENCE WITH ACM PANELS AND SYSTEMS. THE ALUMINUM COMPOSITE MATERIAL MANUFACTURER SHALL WARRANT FOR A PERIOD OF 15 YEARS PER AAMA 2604. MANUFACTURER'S WARRANTY NOTE AT TIME OF PROJECT BID: THE MANUFACTURER'S WARRANTY IS LIMITED TO REPLACEMENT OF DEFECTIVE MATERIAL ON THAN INSTALLATION OF THE SAME. FAULTY INSTALLATION SHALL BE CORRECTED BY THE INSTALLER CONTRACTOR. THE WARRANTY REQUIRED HEREIN IS THE SOLE REMEDY AGAINST THE MANUFACTURE AND THERE ARE NO IMPLIED WARRANTIES. IN ANY EVENT THE MANUFACTURE SHALL BE LIABLE FOR INCIDENTALS OR

CONSEQUENTIAL DAMAGE. PACKAGE, SHIP, STORE, HANDLE AND INSTALL PER MANUFACTURER'S RECOMMENDATIONS

ILLINOIS CENTRAL COLLEGE

THE HOH GROUP, INC. ARCHITECTS | ENGINEES


> 623 COOPER COURT SCHAUMBURG, IL 60173 (312) 346-8181

STATEMENT OF COMPLIANCE

HAVE PREPARED OR CAUSED TO BE PREPARED UNDER MY DIRECT THAT. TO THE BEST OF MY KNOWLEDGE AND BELIEF AND TO THE COMPLIANCE WITH THE 2015 INTERNATIONAL BUILDING COD DEPARTMENT/CODE ENFORCEMENT AND THE ILLINOIS ACCESSIBILITY CODE, 71 IL ADM. CODE 400.

12/21/2022

ARCHITECT/ENGINEER 001.024865 ILLINOIS REGISTRATION NO.

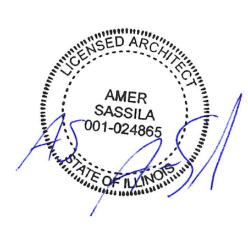

ISSUED FOR BID ISSUE DESCRIPTION

WORKFORCE TRAINING FACILITIES IMPROVEMENTS

1 College Dr, East Peoria, IL 61635


PROJECT NO. 5538

ARCHITECTURAL SPECIFICATIONS

DESIGN BY: DRAWN BY:

CHECKED BY: JBA / AS

SHEET NO.

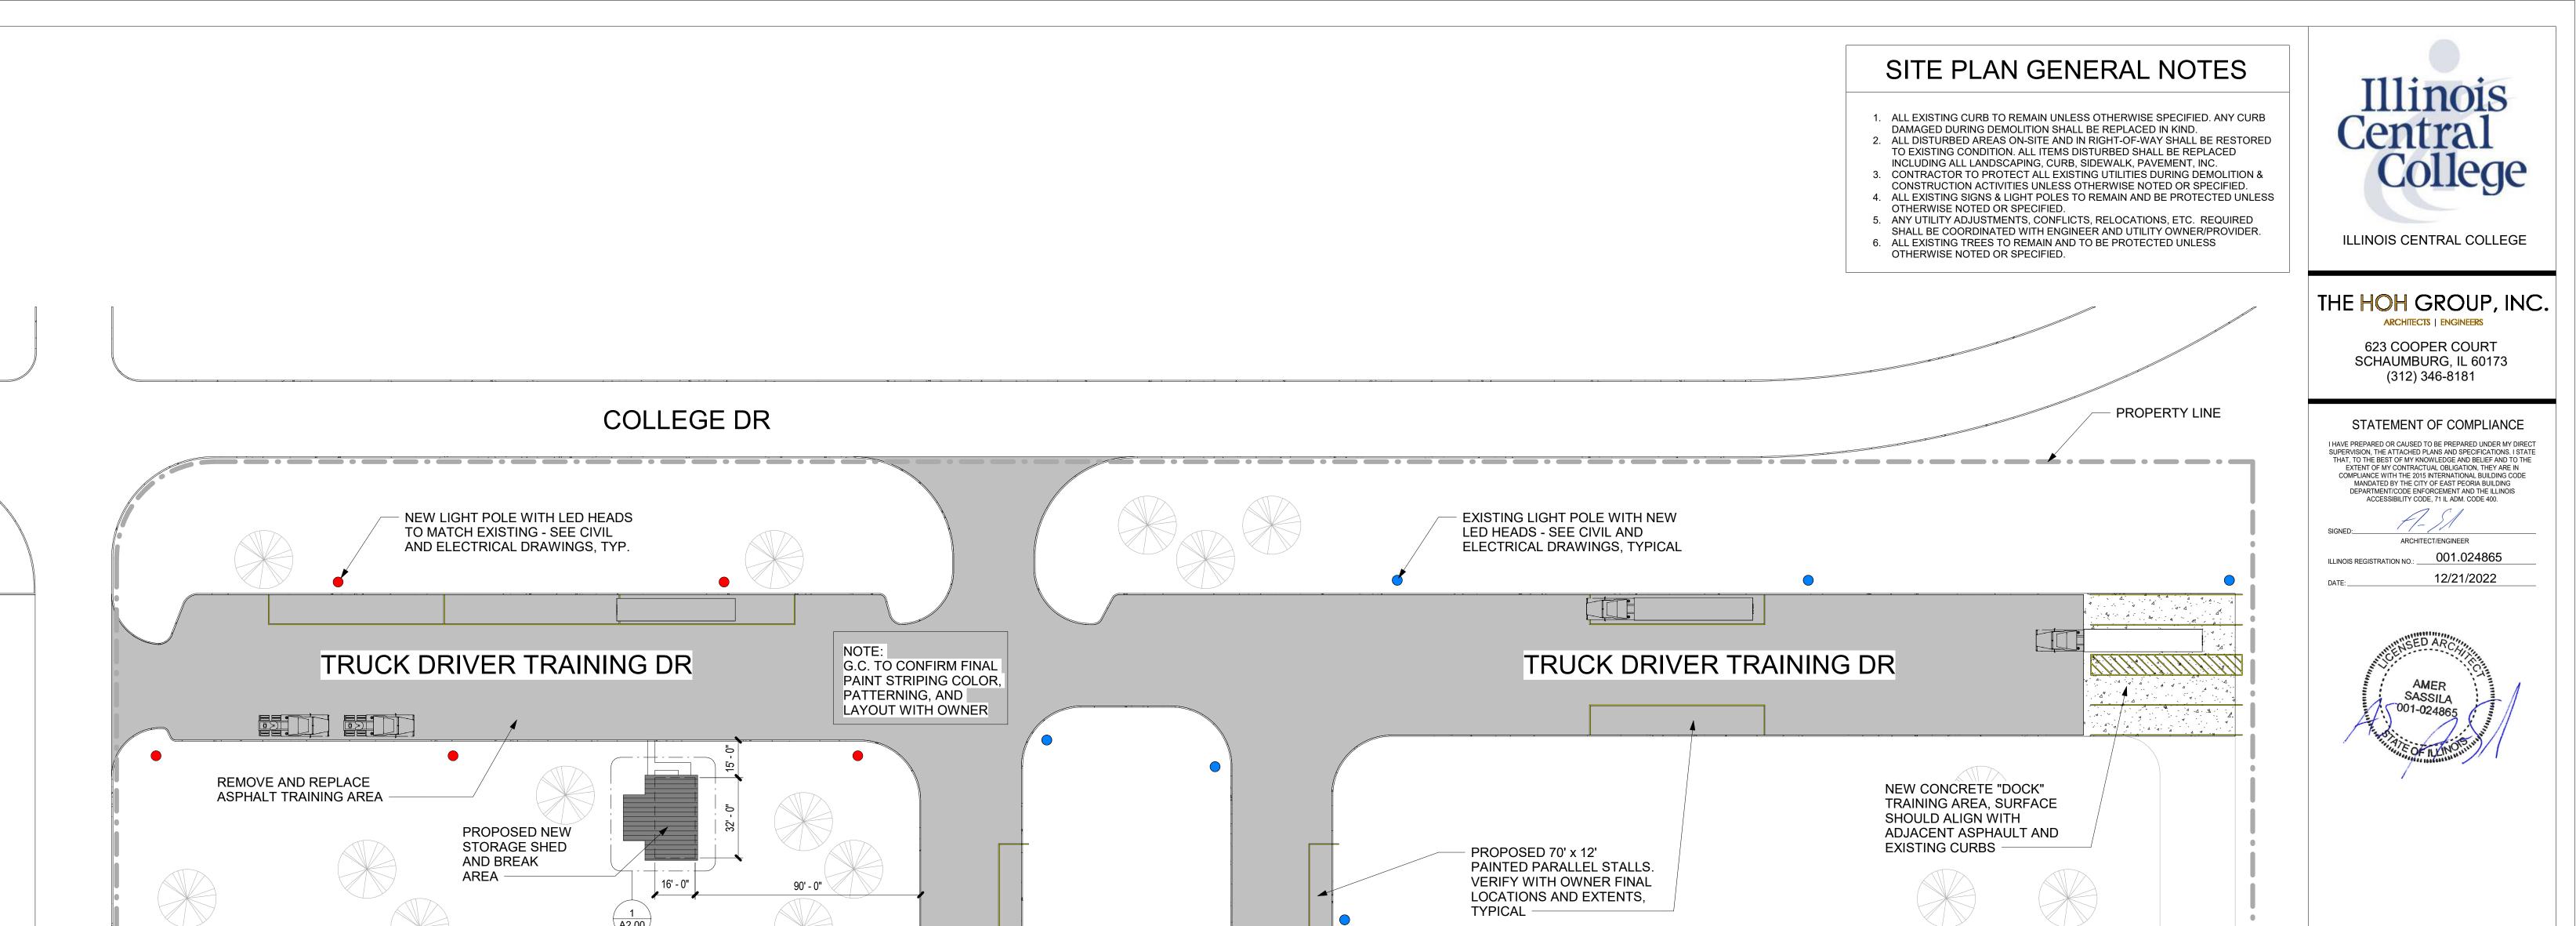

ISSUED FOR BID ISSUE DESCRIPTION

EXISTING TRUCKING DRIVE (N.I.C.)

SITE PLAN LEGEND

NEW CONCRETE "DOCK" APRON

REMOVE AND REPLACE ASPHALT PAVING

NEW LIGHT POLES, SEE CIVIL DRAWINGS

EXISTING LIGHT POLES, SEE CIVIL DRAWINGS

WORKFORCE **TRAINING FACILITIES IMPROVEMENTS**

1 College Dr, East Peoria, IL 61635

PROJECT NO. 5538

ARCHITECTURAL SITE PLAN

TM / IM TM / IM DRAWN BY: CHECKED BY: JBA / AS

SHEET NO.

NORTH

1 PROPOSED SITE PLAN
1" = 30'-0"

A1.00

DR

LAKESIDE

EXISTING -BUILDING

(N.I.C.)

I HAVE PREPARED OR CAUSED TO BE PREPARED UNDER MY DIRECT SUPERVISION, THE ATTACHED PLANS AND SPECIFICATIONS. ISTATE THAT, TO THE BEST OF MY KNOWLEDGE AND BELIEF AND TO THE EXTENT OF MY CONTRACTUAL OBLIGATION, THEY ARE IN COMPLIANCE WITH THE 2015 INTERNATIONAL BUILDING CODE MANDATED BY THE CITY OF EAST PEORIA BUILDING DEPARTMENT/CODE ENFORCEMENT AND THE ILLINOIS ACCESSIBILITY CODE, 71 IL ADM. CODE 400.

ARCHITECT/ENGINEER 001.024865 ILLINOIS REGISTRATION NO.: ___

12/21/2022



ISSUED FOR BID ISSUE DESCRIPTION

WORKFORCE **TRAINING FACILITIES IMPROVEMENTS**

1 College Dr, East Peoria, IL 61635

PROJECT NO. 5538

PAVEMENT DETAILS

TM / IM DESIGN BY: TM / IM DRAWN BY:

CHECKED BY: JBA / AS

SHEET NO.

A1.01

CURB AND GUTTER - RIGHT OF WAY

Doweled contraction join

construction option:

2 (50) deep, and seal.

Short radius curve

(Such as entrances,

side streets and ramp returns).

Pavement expansion joint

BARRIER CURB

BARRIER CURB

 (B-22.45)
 (450)
 (50)
 (125)
 (225)
 (25)

 B-9.24
 24
 2
 5
 9
 1

 (B-22.60)
 (600)
 (50)
 (125)
 (225)
 (25)

★ For corner islands only.

with (or without) dowels

Saw at 4 to 24 hours, and seal.

(Placed in prolongation with pavement joints)

Form with $\frac{1}{8}$ (3) thick steel template

2-No. 4 (No. 13) bars

This dimension shall be

joint on the adjacent

curb type.

DEPRESSED CURB (TYPICAL)

Mountable curb shown

9 (225) when PCC base

course 8≰200) 10 (250) when PCC base

ADJACENT TO PCC BASE COURSE

Slope 2%

M-2.06 (M-5.15) and M-2.12 (M-5.30)

Drainage casting

without curb box

- Back of curb

Full depth & width

1 (25) - thick (min.)

joint filler.

preformed expansion

is omitted.

Standard 420001

maintained

t = Thickness of pavement.

longitudinal construction joint shown on

the tie bar and the back of the curb shall be

only be required for monolithic construction.

See Standard 606301 for details of corner

All dimensions are in inches (millimeters)

CONCRETE CURB TYPE B

AND COMBINATION

CONCRETE CURB AND GUTTER

STANDARD 606001-07

curb type.

TO CURB RAMP ACCESSIBLE

TO THE DISABLED

Slope 5% max.

with 2 (50) min. cl.

2-No. 4 (No. 13) bars

placed at mid-depth

(when space permits)

Drainage casting

with curb box

2-No. 4 (No. 13) bars

placed at mid-depth

(when space permits)

18 (450) long

dowel bars


ADJACENT TO PCC PAVEMENT OR PCC BASE COURSE

MOUNTABLE CURB

MOUNTABLE CURB

M-2.06 6 2 4 2

PCC SIDEWALK & DRIVEWAY SCALE: 1"=1'-0"

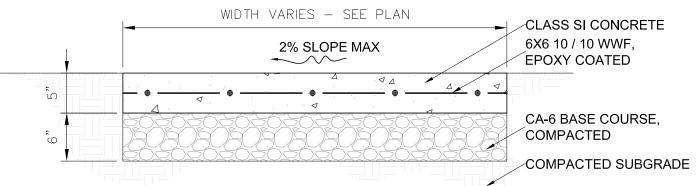

1. ALL SIDEWALKS SHALL BE CONSTRUCTED WITH IDOT CLASS SI CONCRETE, NOT LESS

THAN 3500 P.S.I. CONCRETE AT 14 DAYS. 2. SIDEWALK THICKNESS CROSS DRIVEWAY SHALL BE A MINIMUM 8".


3. REFER TO EXPANSION JOINT DETAIL 4. THE TRANSVERSE JOINTS SHALL EXTEND TO 1/4 THE DEPTH OF THE SIDEWALK, SHALL NOT BE MORE THAN 1/4" IN WIDTH, AND SHALL BE EDGED HAVING A 1/4 INCH RADIUS. NO SLAB SHALL BE LONGER THAN 6 FEET NOR LESS THAN 4 FEET ON ANY ONE SIDE.


TACK COAT @ 0.10 GAL/SY - 1-1/2" HMA SURFACE COURSE -2-1/2" HMA BINDER COURSE 12" - COMPACTED CA-6 AGGREGATE BASE COURSE COMPACTED SUBGRADE *SEE SPECIFICATIONS


HMA PAVEMENT

SCALE: 1"=1'-0"

1. FOR UNSUITABLE SUBGRADES UNDERCUT 2 ADDITIONAL FOOT MAXIMUM.

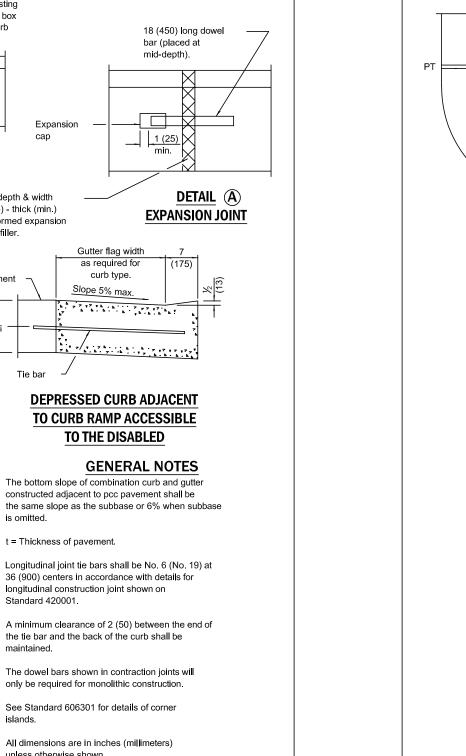

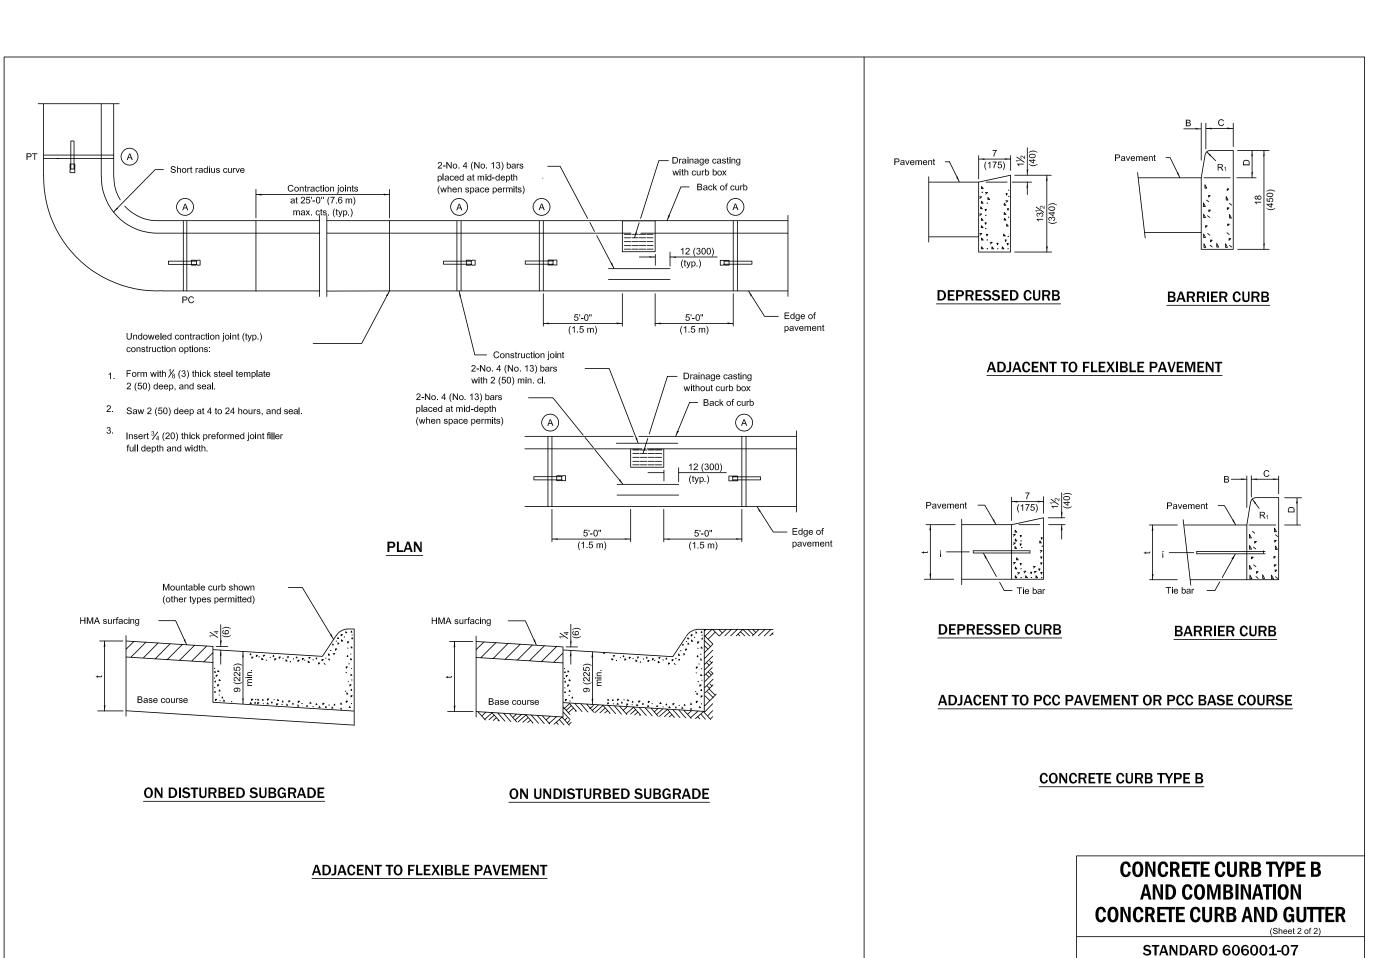

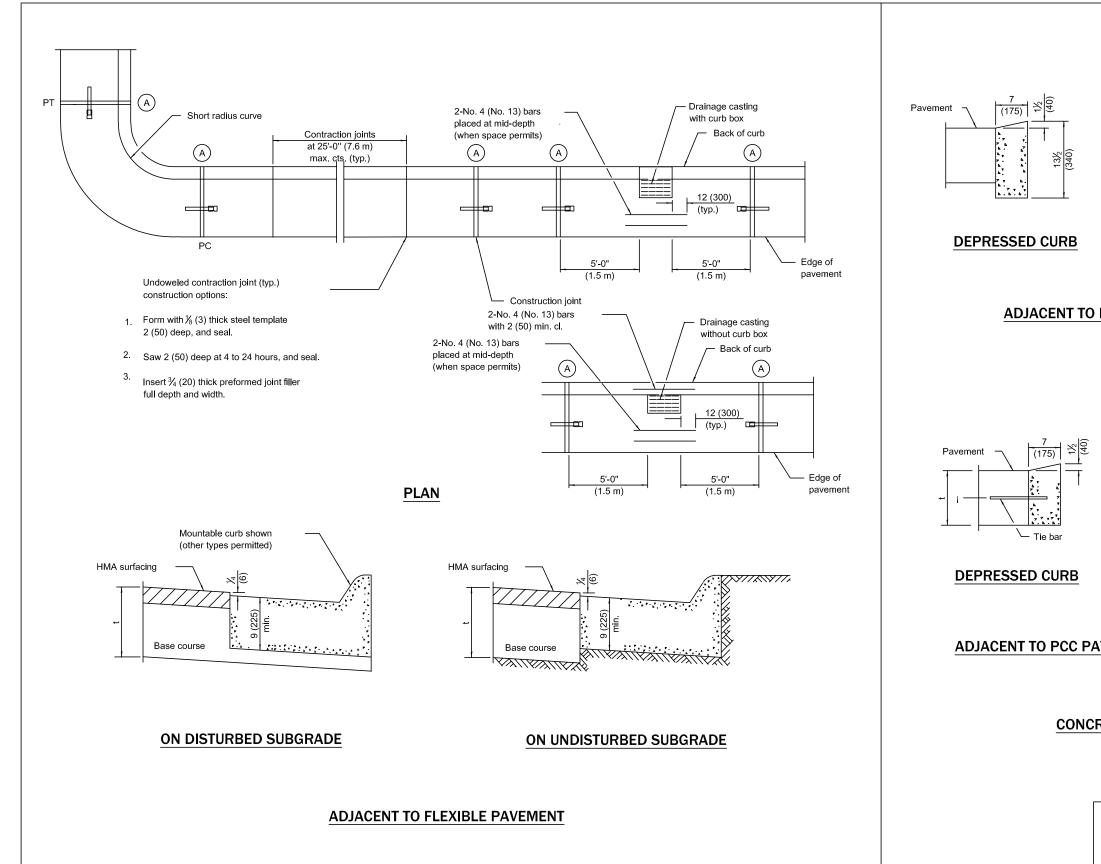

HARDWARE TYPES

TYPE A (EXT-ENTRY)

3 HINGES 1 ENTRANCE LOCKSET 1 KICKPLATE 1 THRESHOLD 1 SWEEP (BRUSH SEAL) 1 RAIN DRIP CAP WEATHERSTRIPPING

TYPE B (EXT-ENTRY) 6 HINGES 1 ENTRANCE LOCKSET 2 KICKPLATES 1 RIM CYLINDER SET 2 SWEEPS (BRUSH SEAL) 2 CLOSERS 1 RAIN DRIP CAP 1 THRESHOLD

WEATHERSTRIPPING

DOOR NOTES

1. VERIFY HARDWARE FUNCTIONS AND KEY REQUIREMENTS WITH OWNER. 2. ALL DOOR HARDWARE TO COMPLY WITH ADA

REQUIREMENTS AND AS DEFINED IN ANSI A-117.1. 3. DOOR HARDWARE SHALL BE CAPABLE OF OPERATION WITH THE USE OF ONE (1) HAND AND SHALL NOT REQUIRE TIGHT PINCHING, TIGHT GRASPING OR TWISTING OF THE WRIST TO OPERATE. THUMBTURN DEADBOLTS ARE PROHIBITED, LEVER OR PADDLE DEADBOLT RELEASES ARE ACCEPTABLE. 4. DOOR THRESHOLD SHALL NOT EXCEED ONE-HALF INCH

(\") IN HEIGHT, THRESHOLDS EXCEEDING ONE QUARTER INCH (|") IN HEIGHT SHALL HAVE A 1:2 BEVEL. 5. ALL ENTRY DOORS AND FIREWALL DOORS SHALL BE EQUIPPED WITH FINISH HARDWARE WHICH MEETS OR EXCEEDS THE REQUIREMENTS OF THE LOCAL CODES.

6. ALL REQUIRED ENTRY/ EXIT AND FIREWALL DOORS

SHALL BE OPERABLE FROM THE INSIDE WITHOUT THE USE OF A KEY OR SPECIAL KNOWLEDGE. 7. SIGNS. IF REQUIRED. SHALL BE READILY VISIBLE AND DURABLE WITH LETTERS NOT LESS THAN ONE INCH HIGH ON A CONTRASTING BACKGROUND.

8. DOORS AND FRAMES SHALL BE REINFORCED FOR SURFACE MOUNTED HARDWARE AS NECESSARY. DRILLING AND TAPPING FOR SURFACE MOUNTED HARDWARE SHALL BE PERFORMED BY INSTALLATION CONTRACTOR. PROVIDE PROPER DOOR REINFORCING TO ELIMINATE THE USE OF THRU-BOLTS.

9. ALL STANDARD TYPE HARDWARE WILL BE LOCATED

AT THE MANUFACTURER'S STANDARD LOCATION AS

SILENCERS, THREE FOR SINGLE SWING OPENING AND

10. ALL FRAMES SHALL BE PREPARED FOR DRILLED DOOR

TWO PER HEAD FOR DOUBLE SWING OPENINGS.

11. ALL FRAMES MUST BE SET PLUMB AND LEVEL TO

12. FRAMES TO BE WELDED FULL DEPTH & WIDTH.

14. DOOR SURFACES WITHIN 10" OF THE FLOOR OR

15. PROVIDE A THRESHOLD AND WEATHERSTRIP

SUBMITTAL REVIEW.

SHALL BE CAPPED.

13. HARDWARE ITEMS SUCH AS PANIC EXIT DEVICES,

DEADLOCKS, ETC. WILL ALSO BE LOCATED AT THE

MANUFACTURER'S STANDARD LOCATION UNLESS

SPECIFICALLY ADDRESSED IN SUBMITTAL AND/OR

WIDTH OF THE DOOR. HORIZONTAL OR VERTICAL

ANY CAVITIES CREATED BY ADDING A KICKPLATE

PACKAGE FOR ALL EXTERIOR DOORS INCLUDING

SWEEPS AT BOTTOM. PROVIDE MANUFACTURER'S

STANDARD PACKAGE AT ALL STOREFRONT DOORS.

24. ALL EXTERIOR DOORS TO HAVE A RAIN CHANNEL CAP

THE WIDTH OF THE DOOR & JAMBS COMBINED.

COMPRESSIBLE GASKETS AROUND FRAME AND DOOR

ENSURE PROPER OPERATION OF DOORS AND

SHOWN ON DOOR AND FRAME ELEVATION.

LOCATIONS (AND ANY OTHER LOCATIONS REQUIRED BY CODE):

> DOORS. FIXED PANELS IN SWINGING DOORS.

2. ALL GLAZING SHALL COMPLY WITH THE REQUIREMENTS OF THE LOCAL CODES.

AN INDIVIDUALLY PANE IS GREATER THAN 9 S.F., THE EXPOSED BOTTOM EDGE IS LESS THAN 18" ABOVE THE FLOOR. THE EXPOSED TOP EDGE IS GREATER THAN 36" ABOVE THE FLOOR AND ONE OR MORE WALKING SURFACE(S) ARE WITHIN 36"

GROUND SHALL BE SMOOTH AND EXTEND THE FULL 5. FIELD VERIFY ALL ROUGH / FINISHED OPENING JOINTS SHALL BE WITHIN 1/16" OF THE SAME PLANE. DIMENSIONS. 6. IF GLAZING IS IN AN INSULATED UNIT. BOTH LITES MUST BE TEMPERED, LAMINATED SAFETY GLASS, OR

> HAVE 1" INSULATED GLASS, INTERIOR STOREFRONT GLAZING AND DOORS TO HAVE 1/4" SINGLE GLASS UNLESS NOTED.

GLAZING NOTES

1. PROVIDE TEMPERED GLAZING AT THE FOLLOWING

PREFINISHED CORRUGATED METAL

CONCRETE FOUNDATION WALL

ROOFING OVER ICE AND WATER BARRIER

ON 100% COVERAGE OVER 3/4" EXTERIOR

GRADED PLYWOOD, PAINTED TO MATCH

INGRESS AND MEANS OF EGRESS

4. PROVIDE TEMPERED GLAZING IN AN INDIVIDUAL FIXED OR OPERABLE PANEL WHEN ALL OF THE FOLLOWING CRITERIA APPLY. THE EXPOSED AREA OF

HORIZONTALLY FROM THE PLANE OF THE GLAZING.

A COMBINATION OF THE TWO. 7. EXTERIOR STOREFRONT GLAZING AND DOORS TO

2' - 6" 6"6"6"6" 2' - 2" **ANODIZED ALUMINUM** FRAME, TYP. T/ HEADER +7'-2" **TEMPERED** GLASS-TINTED TEMPERED GLAZING MULLION TO BE CENTERED BACKER ROD AND SEALANT, BOTH SIDES, ALL AROUND TYPE A TYPE B T/ SILL +3'-4" 7 DOOR ELEVATION TYPES [/] 3/8" = 1'-0" 6 WINDOW 01 DETAIL 3/4" = 1'-0" **ROOF LINE ABOVE** A5.01/ \A5.00 120/208 V ELECTRICAL PANEL-5' - 0" **INFILL 2x6 WOOD** FRAMED WALL **CAVITIES WITH** ANNODIZED ALUMINUM R-21 FOIL FACED FRAME WITH DOUBLE **BATT INSULATION** PANE TEMPERED RACKING LAYOUT FOR **INSTALLING PER** GLAZING. TYPICAL OF **VISUAL PURPOSES ONLY -**MANUFACTURER'S 2, SEE 6/A2.0 2x4 RACKS SHOWN WITH **REQUREMENTS** FINAL QUANTITY AND LAYOUT BY OWNER **TRAINING** A2.00 3 **STORAGE** <5 | A2.00 100 A5.01 A5.01 A6.00 11' - 8" SIM. (100A)

A2.00

1) PROPOSED BUILDING PLAN

16' - 0"

8' - 8"

ROOFING - PROVIDE BENT EDGE FLASHING AT ALL **EDGES TO PREVENT WATER INFILTRATION** T/ ROOF 12' - 6" PRE-ENGINEERED LAMINATED VENEER LUMBER (LVL) PROVIDED TO SIZE AD T/ EAST WALL INDICATED, PAINT DARK WALNUT IN COLOR -8' - 0" SHERWIN WILLIAMS - SW 6062 OR APPROVED EQUAL PREFINISHED, CORRUGATED METAL PANEL WALL SYSTEM WITH INSULATION BY NUCOR - WAINSCOT COLOR: MIDNIGHT BLACK - WALL COLOR: PEARL GRAY T/ FIN. FLOOR CONCRETE FOUNDATION WALL PREFINISHED CORRUGATED METAL ROOFING **OVER ICE AND WATER BARRIER ON 100% COVERAGE OVER 3/4" EXTERIOR GRADED** 5 EAST ELEVATION PLYWOOD, PAINTED TO MATCH ROOFING - PROVIDE BENT EDGE FLASHING AT ALL 1/4" = 1'-0" **EDGES TO PREVENT WATER INFILTRATION** T/ROOF PRE-ENGINEERED LAMINATED 12' - 6" VENEER LUMBER (LVL) PROVIDED TO SIZE AD INDICATED, PAINT T/ WEST WALL DARK WALNUT IN COLOR -10' - 0" SHERWIN WILLIAMS - SW 6062 OR APPROVED EQUAL T/ EAST WALL 8' - 0" PREFINISHED, CORRUGATED METAL PANEL WALL SYSTEM WITH INSULATION BY NUCOR to - WAINSCOT COLOR: MIDNIGHT BLACK - WALL COLOR: PEARL GRAY CONCRETE FOUNDATION WALL ALL EQUIPMENT AND FURNITURE AS SHOWN BY OWNER, TYPICAL T/ FIN. FLOOR 100' - 0" \ PREFINISHED CORRUGATED METAL ROOFING OVER ICE AND WATER BARRIER ON 100% **COVERAGE OVER 3/4" EXTERIOR GRADED** PLYWOOD, PAINTED TO MATCH ROOFING - PROVIDE BENT EDGE FLASHING AT ALL SOUTH ELEVATION EDGES TO PREVENT WATER INFILTRATION 1/4" = 1'-0" PRE-ENGINEERED LAMINATED VENEER LUMBER (LVL) PROVIDED TO SIZE AD INDICATED, PAINT DARK WALNUT IN COLOR -SHERWIN WILLIAMS - SW 6062 OR T/ ROOF APPROVED EQUAL 12' - 6" PREFINISHED, INSULATED T/ WEST WALL ALUMINUM DOUBLE HUNG, DOUBLE PANED WINDOW, TYPICAL OF 2 10' - 0" PROPOSED FUTURE METAL PLATE BRANDING GRAPHICS AND/OR WALL HUNG **BULLETIN BOARDS BY OWNER** PAINTED INSULATED - MECHANICALLY FASTEN TO CORRUGATED **HOLLOW METAL** WALL PANELS DOOR AND PREFINISHED, CORRUGATED METAL PANEL FRAME WALL SYSTEM WITH INSULATION BY NUCOR - WAINSCOT COLOR: MIDNIGHT BLACK - WALL COLOR: PEARL GRAY T/ FIN. FLOOR 100' - 0" **CONCRETE FOUNDATION WALL** ALL EQUIPMENT AND FURNITURE AS SHOWN BY OWNER, TYPLICAL WEST ELEVATION
1/4" = 1'-0" PREFINISHED CORRUGATED METAL ROOFING **OVER ICE AND WATER BARRIER ON 100%** PRE-ENGINEERED LAMINATED VENEER **COVERAGE OVER 3/4" EXTERIOR GRADED** LUMBER (LVL) PROVIDED TO SIZE AD PLYWOOD, PAINTED TO MATCH ROOFING INDICATED, PAINT DARK WALNUT IN - PROVIDE BENT EDGE FLASHING AT ALL COLOR - SHERWIN WILLIAMS - SW 6062 OR EDGES TO PREVENT WATER INFILTRATION APPROVED EQUAL T/ ROOF 12' - 6" ILLINOIS CENTRAL COLLEGE BRANDING GRAPHIC BY OWNER - PROVIDED BY SIGNAGE 12" 1-1/2" T/ WEST WALL 10' - 0" FLOOR PLAN, VENDOR AS PAINT OVER EXISTING FINISH OR METAL PLATES MECHANICALLY **FASTENED TO CORRUGATED WALL PANELS** ELEVATIONS, PAINTED INSULATED HOLLOW METAL DOOR AND FRAME Illinois / PREFINISHED, METAL PANEL WALL SYSTEM Central (ALL EQUIPMENT WITH NUCOR CORRUGATED WALL PANELS AND FURNITURE College - WAINSCOT COLOR: MIDNIGHT BLACK AS SHOWN BY **DETAILS** - WALL COLOR: PEARL GRAY OWNER, **TYPLICAL** DESIGN BY: T/ FIN. FLOOR DRAWN BY:

Illinois Central

ILLINOIS CENTRAL COLLEGE

THE HOH GROUP, INC. ARCHITECTS | ENGINEERS

623 COOPER COURT SCHAUMBURG, IL 60173 (312) 346-8181

STATEMENT OF COMPLIANCE HAVE PREPARED OR CAUSED TO BE PREPARED UNDER MY DIRECT

THAT. TO THE BEST OF MY KNOWLEDGE AND BELIEF AND TO THE COMPLIANCE WITH THE 2015 INTERNATIONAL BUILDING CODE DEPARTMENT/CODE ENFORCEMENT AND THE ILLINOIS ACCESSIBILITY CODE, 71 IL ADM. CODE 400.

ARCHITECT/ENGINEER

001.024865 ILLINOIS REGISTRATION NO.: _ 12/21/2022



ISSUED FOR BID ISSUE DESCRIPTION

WORKFORCE TRAINING FACILITIES IMPROVEMENTS

1 College Dr, East Peoria, IL 61635

PROJECT NO. 5538

SCHEDULE, **WINDOW & DOOR**

TM / IM TM / IM / WS CHECKED BY: JBA / AS

SHEET NO.

2 NORTH ELEVATION

1/4" = 1'-0"

A2.00

RCP LEGEND - NEW WORK

ILLINOIS CENTRAL COLLEGE

THE HOH GROUP, INC.


623 COOPER COURT SCHAUMBURG, IL 60173 (312) 346-8181

STATEMENT OF COMPLIANCE

I HAVE PREPARED OR CAUSED TO BE PREPARED UNDER MY DIRECT SUPERVISION, THE ATTACHED PLANS AND SPECIFICATIONS. I STATE THAT, TO THE BEST OF MY KNOWLEDGE AND BELIEF AND TO THE EXTENT OF MY CONTRACTUAL OBLIGATION, THEY ARE IN COMPLIANCE WITH THE 2015 INTERNATIONAL BUILDING CODE MANDATED BY THE CITY OF EAST PEORIA BUILDING DEPARTMENT/CODE ENFORCEMENT AND THE ILLINOIS ACCESSIBILITY CODE, 71 IL ADM. CODE 400.

ARCHITECT/ENGINEER

ILLINOIS REGISTRATION NO.: _____001.024865 12/21/2022

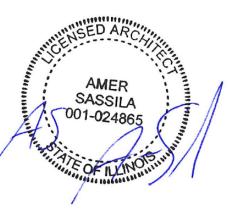

ISSUED FOR BID ISSUE DESCRIPTION

WORKFORCE **TRAINING FACILITIES IMPROVEMENTS**

PROJECT NO. 5538


REFLECTED **CEILING PLAN**

DESIGN BY: DRAWN BY: CHECKED BY: JBA / AS

SHEET NO.

A3.00

1 REFLECTED CEILING PLAN 1/2" = 1'-0"

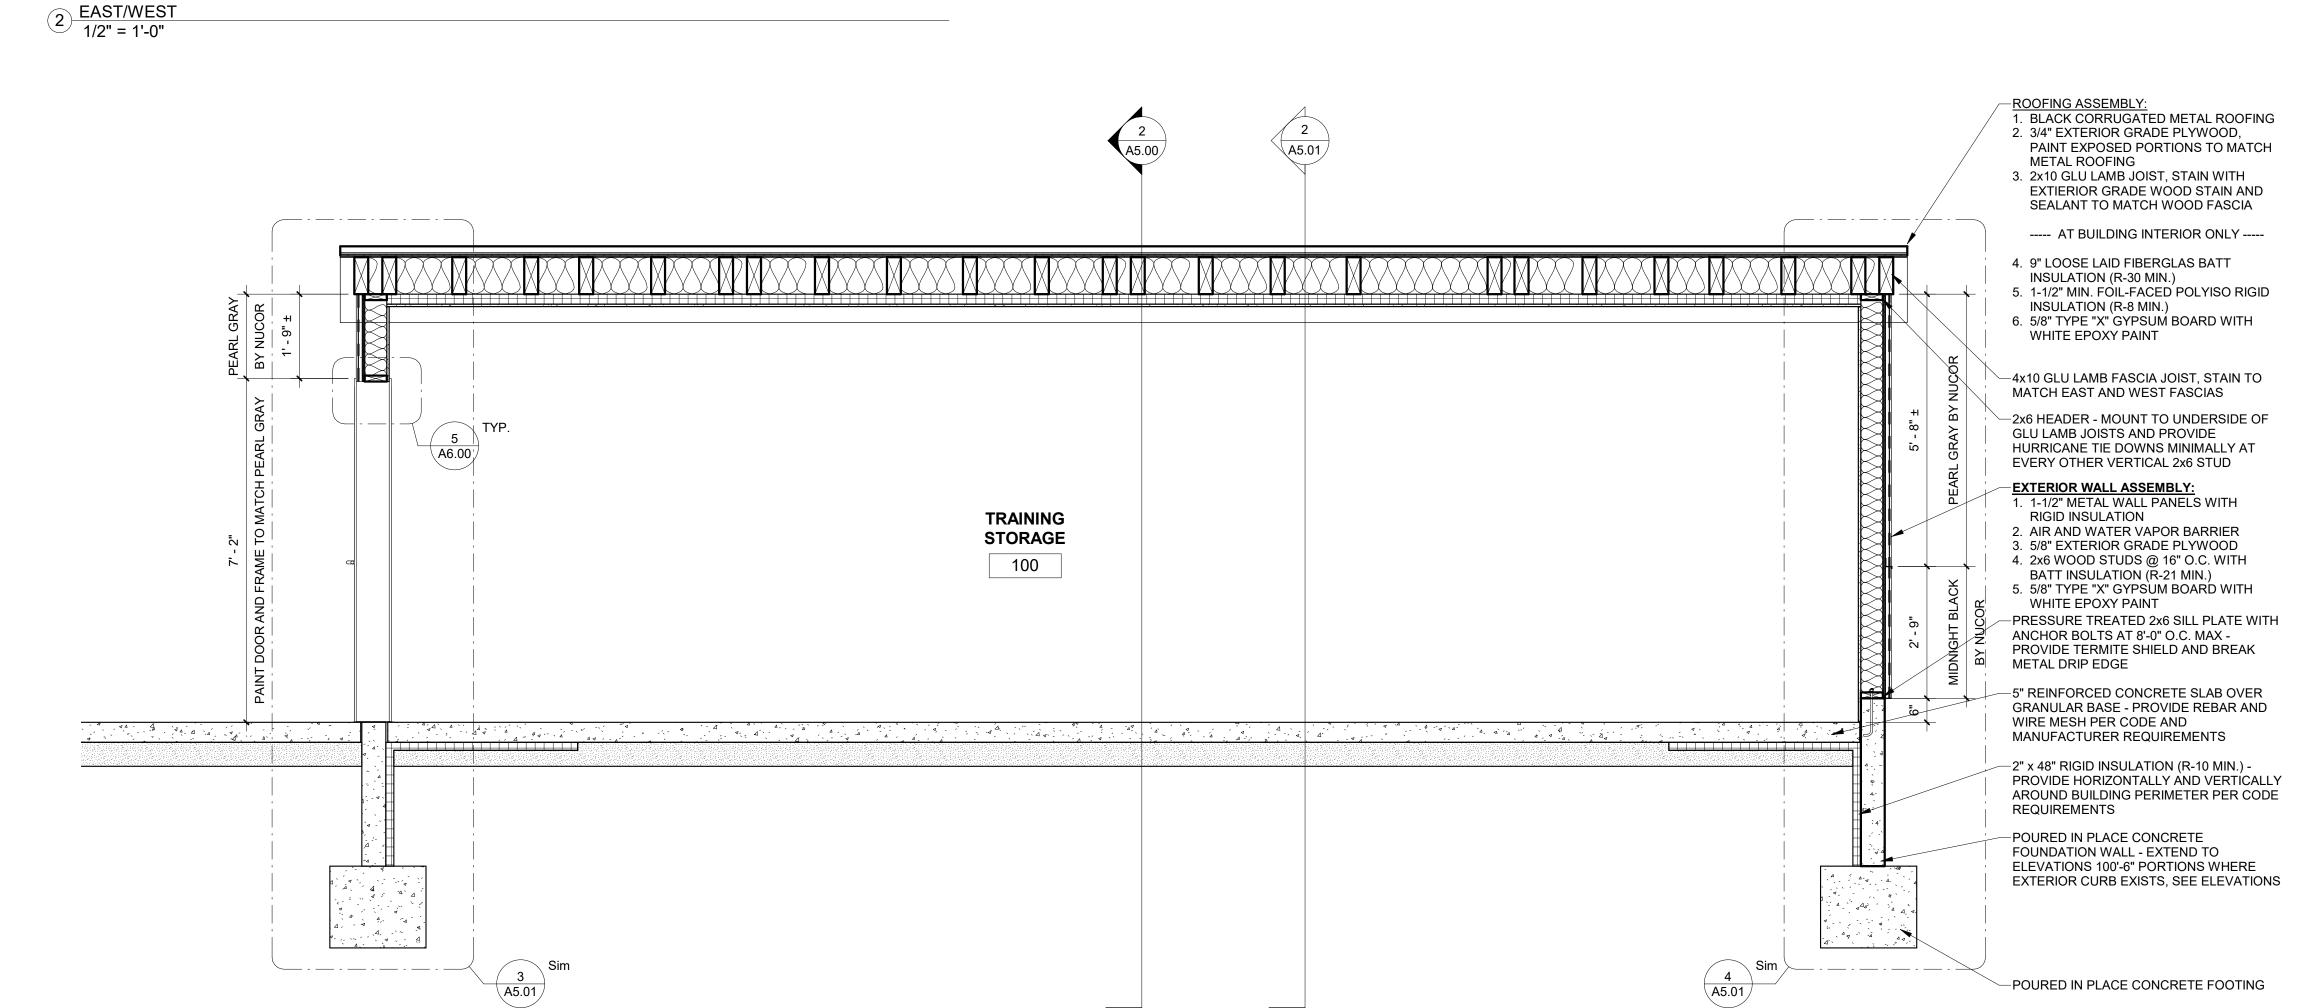



ILLINOIS CENTRAL COLLEGE

THE HOH GROUP, INC. ARCHITECTS | ENGINEERS

623 COOPER COURT SCHAUMBURG, IL 60173 (312) 346-8181

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NED: ARCHITECT/ENGINEER

ILLINOIS REGISTRATION NO.: 001.024865

DATE: 12/21/2022





ISSUED FOR BID

WORKFORCE TRAINING FACILITIES IMPROVEMENTS

1 College Dr, East Peoria, IL 61635

PROJECT NO. 5538

OVERALL SECTIONS

DESIGN BY: TKM
DRAWN BY: TKM
CHECKED BY: JBA / AS

SHEET NO.

A5.00

OVERALL BUILDING SECTION -

1 NORTH/SOUTH 1/2" = 1'-0"

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MANDATED BY THE CITY OF EAST PEORIA BUILDING
DEPARTMENT/CODE ENFORCEMENT AND THE ILLINOIS
ACCESSIBILITY CODE, 71 IL ADM. CODE 440.

NED: ARCHITECT/ENGINEER

ILLINOIS REGISTRATION NO.: 001.024865

12/21/2022



NOT FOR CONSTRUCTION

ISSUED FOR BID

ISSUE DESCRIPTION

WORKFORCE TRAINING

IMPROVEMENTS

1 College Dr, East Peoria, IL 61635

FACILITIES

PROJECT NO. 5538


EXTERIOR WALL SECTIONS

DESIGN BY: TKM
DRAWN BY: TKM

CHECKED BY: JBA / AS

SHEET NO.

A5.01

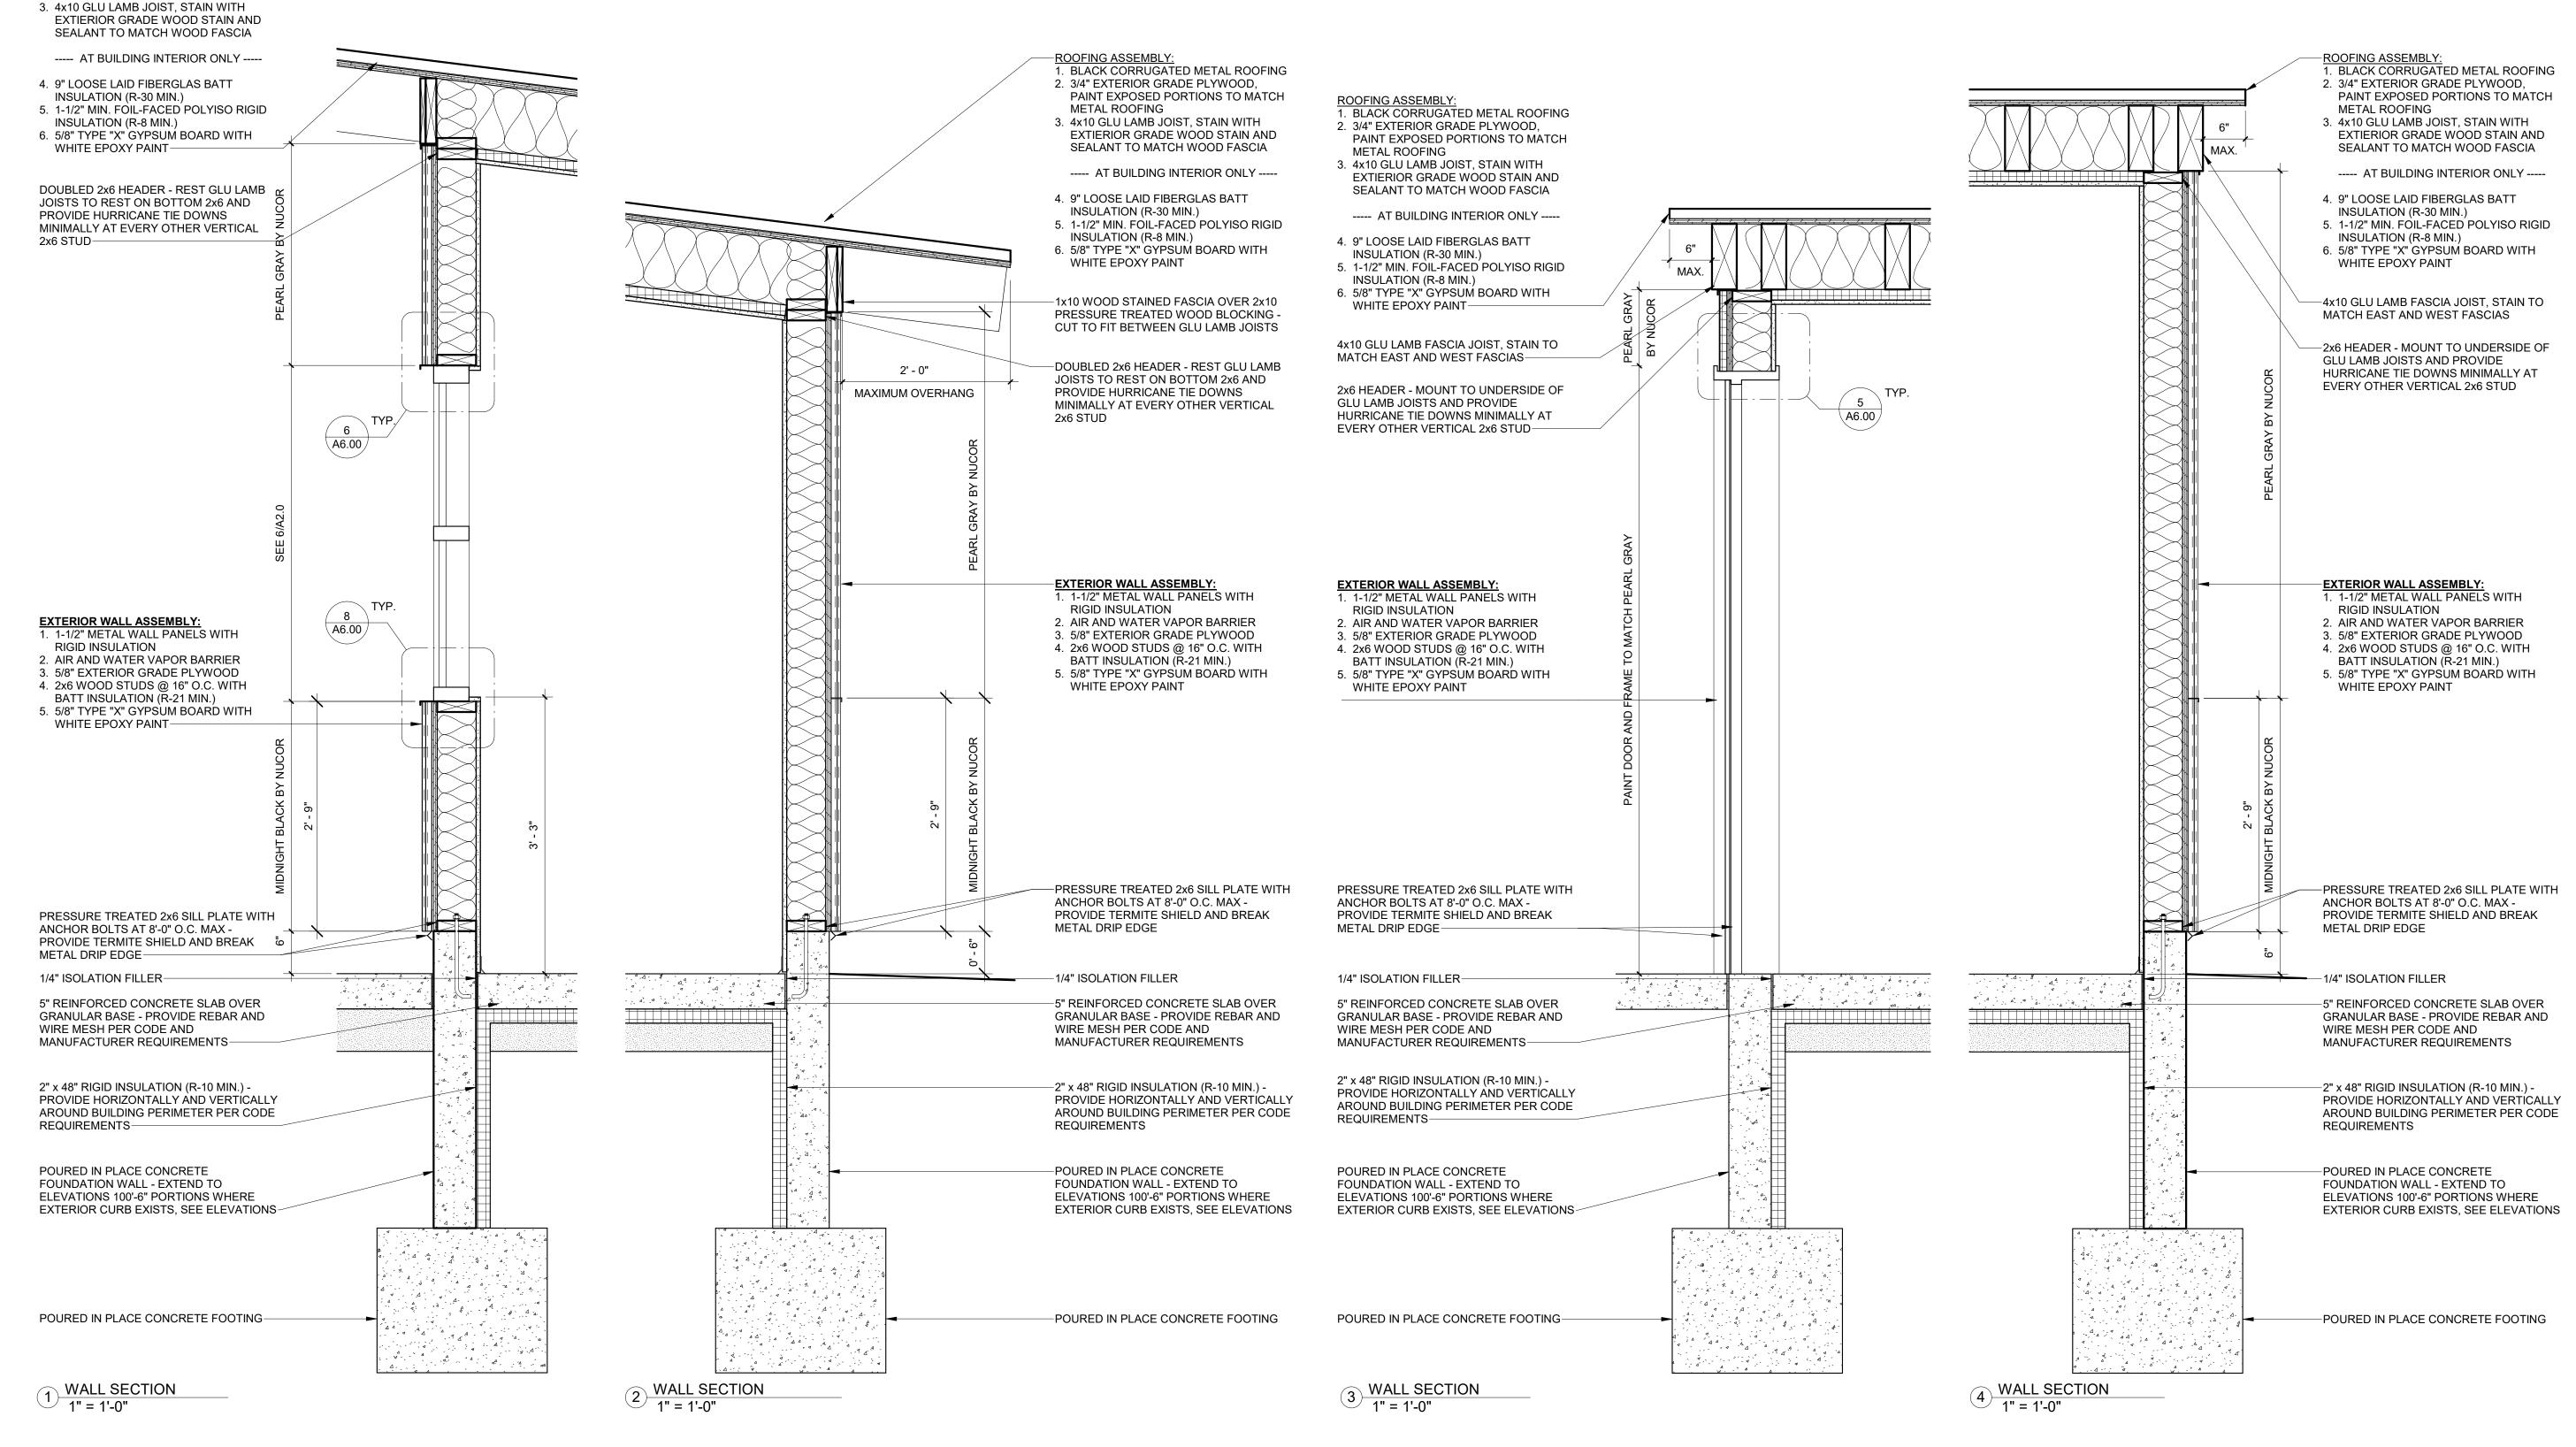


ROOFING ASSEMBLY:

METAL ROOFING

. BLACK CORRUGATED METAL ROOFING

PAINT EXPOSED PORTIONS TO MATCH

2. 3/4" EXTERIOR GRADE PLYWOOD,

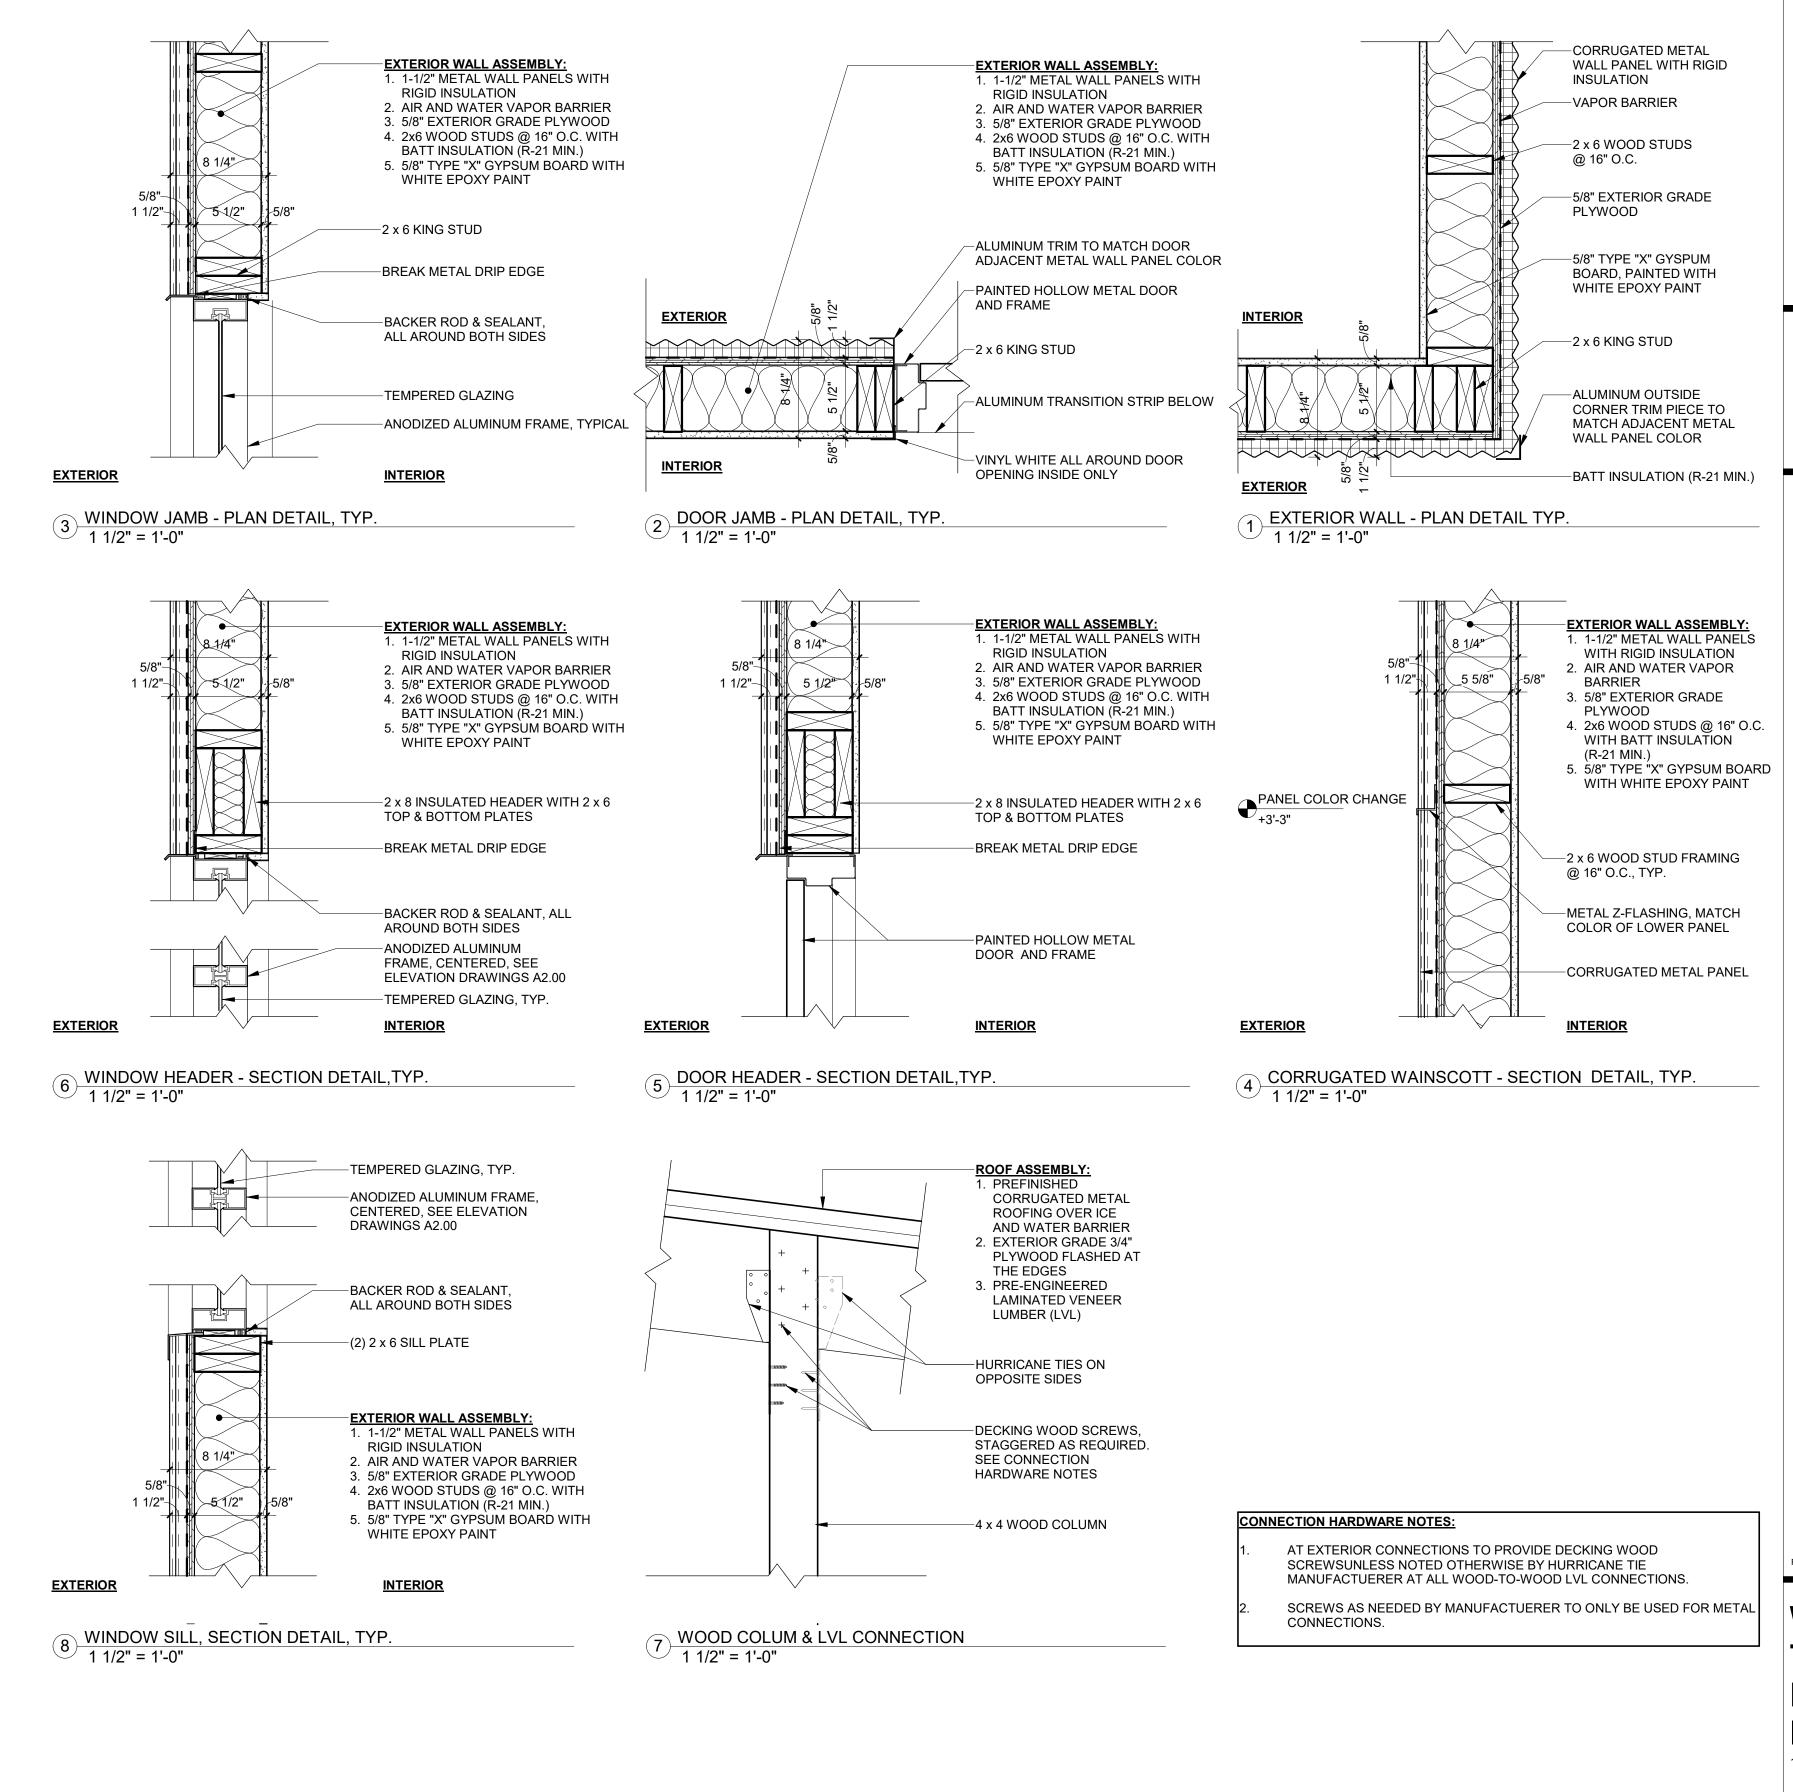

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IGNED:

ARCHITECT/ENGINEER

DATE: 001.024865

12/21/2022



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1 College Dr, East Peoria, IL 61635

PROJECT NO. 5538

DETAILS

DESIGN BY: TKM
DRAWN BY: TKM / WS

SHEET NO.

CHECKED BY: AS

A6.00